

BAPTIST HEALTH SYSTEM BAPTIST SOUTH CAMPUS - JACKSONVILLE, FLORIDA


C&A #3943 CREATE TIMESHARE OFFICE WITH FURNITURE

MOB 2, 3RD FLOOR, SUITE 2371 NOVEMBER 09, 2011

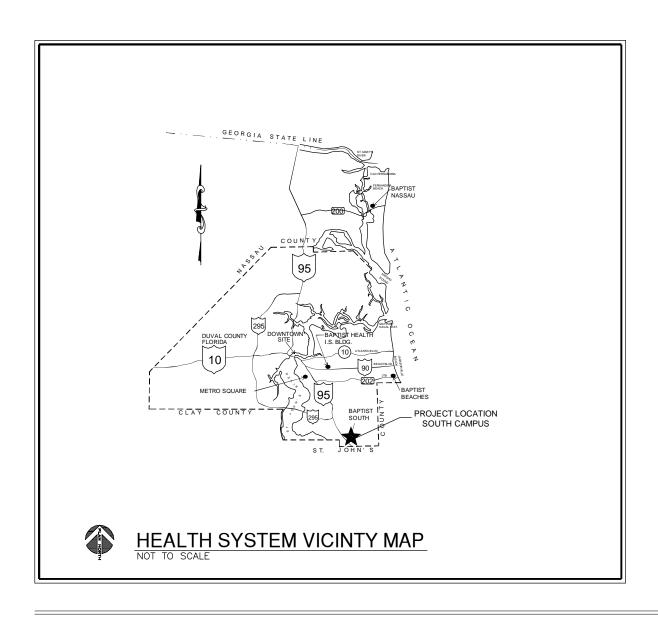

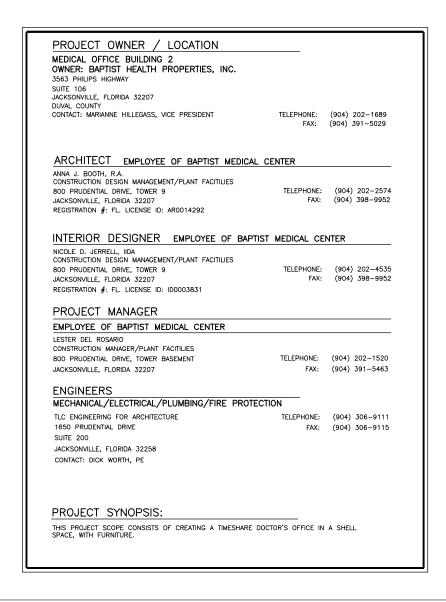



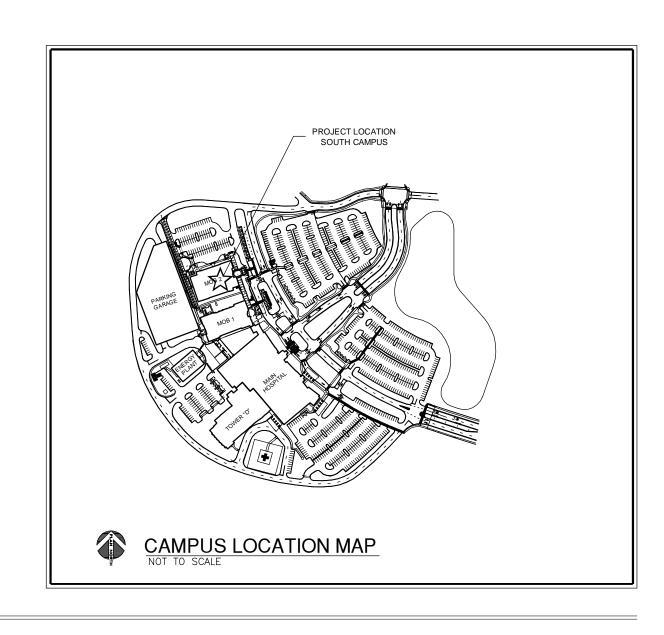

INDEX OF DRAWINGS

ARCHITECTURAL

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- PARTIAL THIRD FLOOR NEW WORK SANITARY PLUMBING P2.1 PARTIAL THIRD FLOOR - NEW WORK - WATER - PLUMBING
- **DETAILS PLUMBING**

PLUMBING

RISER DIAGRAM - SANITARY - PLUMBING

FIRE PROTECTION


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MECHANICAL

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- ELECTRICAL SPECIFICATIONS
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- PARTIAL 3RD FLR PLAN POWER & DEMOLITION
- PARTIAL 3RD FLR PLAN LIGHTING
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EGRESS CALCULATIONS

MEANS OF EGRESS OCC. LOAD 1ST FLOOR 20,165 / 100 = 2022ND FLOOR 20,159 / 100 = 2023RD FLOOR 20,159 / 100 = 2024TH FLOOR 20,159 / 100 = 2025TH LEVEL 19,220 / 100 = 192TOTAL: 1,000

EGRESS WIDTH (FIFTH FLOOR)

STAIRWAY (0.3" OCC W/SPRINKLER SYS) (19[′]2) (.3) = 57.6"

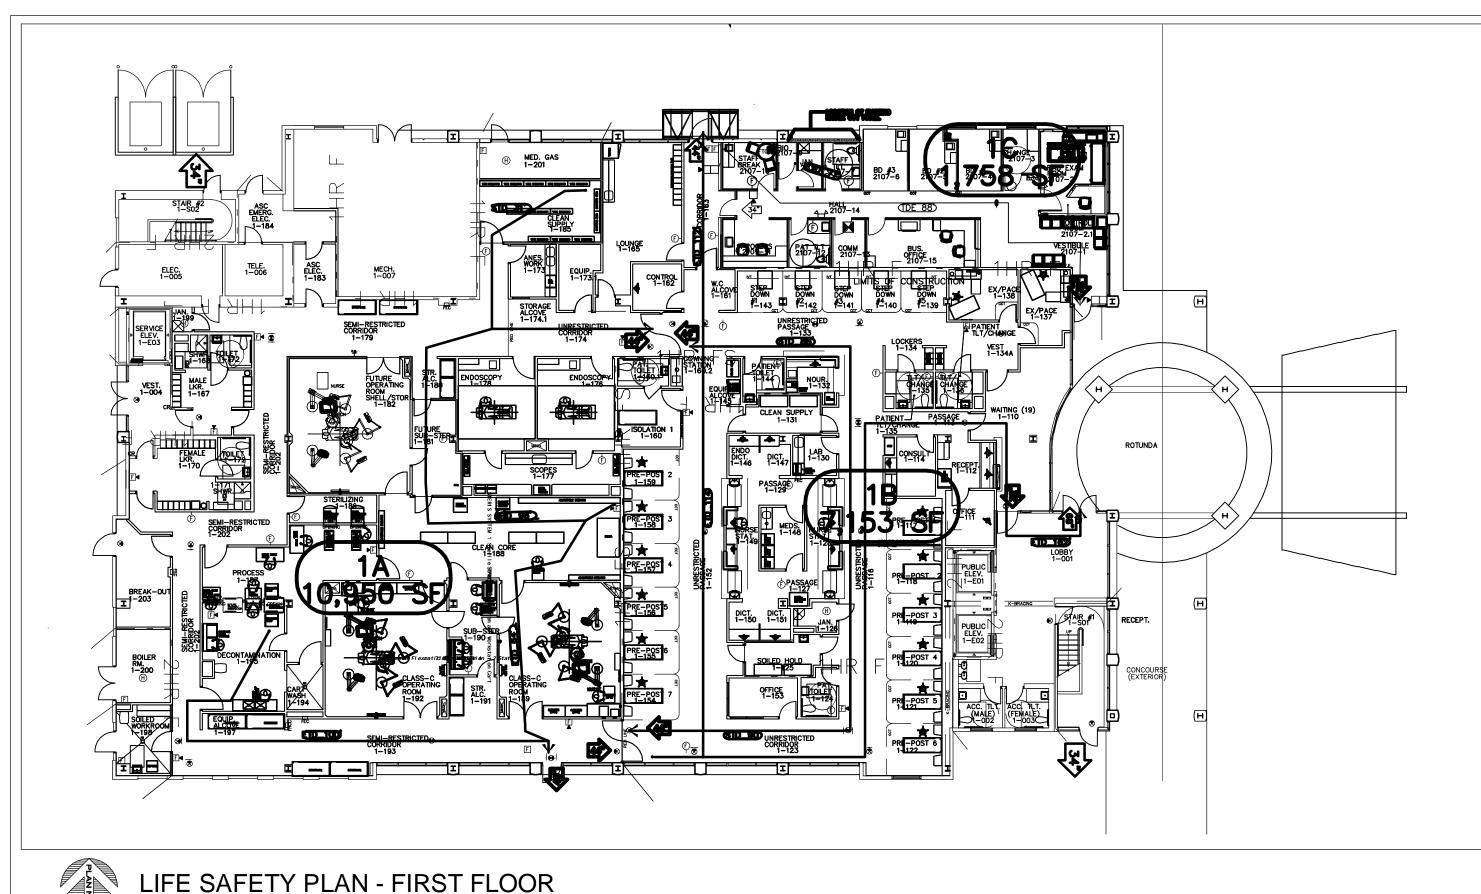(192) (0.2) = 38.4

OTHER COMP. (0.2" OCC W/SPRINKLER SYS)

-DESIGN STAIRWAY WIDTHS ARE 48" @ STAIR #1 AND 42" @ STAIR #2

-(2) STAIRS ARE ACCESSIBLE TOTALING 90" > 57.6" -DOORS TO THE STAIRWAY ARE (2) @ 34" CLEAR -(2) DOORS EQUAL 68" > 38.4"

EGRESS WIDTH (2ND THROUGH 4TH FLOOR INDIVIDUALLY) STAIRWAY (0.3" OCC W/SPRINKLER SYS)

(202) (.3) = 60.6" OTHER COMP. (0.2" OCC W/SPRINKLER SYS)

(202) (0.2) = 40.4

-DESIGN STAIRWAY WIDTHS ARE 48" @ STAIR #1

AND 42" @ STAIR #2

-(2) STAIRS ARE ACCESSIBLE TOTALING 90" > 60.6"

-DOORS TO THE STAIRWAY ARE (2) @ 34" CLEAR

-(2) DOORS EQUAL 68" > 40.4"

EGRESS WIDTH (GROUND FLOOR / LEVEL OF DISCHARGE


NOT APPLICABLE STAIRWAYS = GROUND LEVEL = 202 OCCUPANTS

202 OCCUPANTS X (0.2 /OCC FOR COMP.)= 40.4" REQUIRED WIDTH

44"

TOTAL =

FIRST LEVEL DOORS PROVIDED = (2 @ 68") + (1 @ 46") + (1 @ 34") = 216" > 40.4"

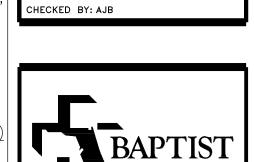

ISSUE DATE: NOVEMBER 09, 2011

DRAWN BY: AJB, NDJ, JRD

ISSUE: PERMIT

SOUTH

MEDICAL CENTER

BAPTIST MEDICAL CENTER INTERSTATE 95 EXIT 335 14550 OLD ST. AUGUSTINE ROAD JACKSONVILLE, FLORIDA 32258

CREATE TIMESHARE OFFICE WITH FURNITURE MOB2 SUITE #2371

SHEET NAME:
FIRST FLOOR
111101 120011
LIFE SAFETY PLAN,
,
CODE INFORMATION

SCALE: AS NOTED

LOG NO. T:\Baptist Health...\Drawings\

C & A FN: 3943

Est. Project GSF: 1,894

BOMA SF: 1,792

AL100 2 OF 16

HANDICAPPED ACCESSIBILITY

PROJECT IS ARCHITECTURALLY BARRIER FREE 100% ACCESSIBLE

APPLICABLE CODES

SCALE: N.T.S.

EXISTING BUILDING

- 1. FLORIDA BUILDING CODE, 2004 EDITION, WITH 2005 AND 2006 SUPPLEMENTS.
- 2. FLORIDA EDITION OF NATIONAL FIRE PROTECTION ASSOCIATION (NFPA) 101 LIFE SAFETY CODE, 2004 EDITION OF THE FLORIDA FIRE PREVENTION CODE
- 3. NFPA 221, STANDARD FOR FIRE WALLS AND FIRE BARRIER WALLS
- 4. FLORIDA BUILDING CODE CHAPTER 11 ACCESSIBILITY CODE 2004 EDITION WITH 2005 AND 2006 SUPPLEMENTS
- 5. FLORIDA MECHANICAL CODE, 2004 EDITION WITH 2006 SUPPLEMENT FLORIDA PLUMBING CODE, 2004 EDITION WITH 2005 AND 2006 SUPPLEMENTS
- 6. NFPA 70, NATIONAL ELECTRIC CODE, 2002 EDITION

BUILDING CLASSIFICATION

OCCUPANCY TYPE: BUSINESS

FBC OCCUPANCY GROUP B: PROFESSIONAL SERVICE

CONSTRUCTION TYPE:

FBC CONSTRUCTION TYPE II B, SECTION 602, 2006 EDITION AND TABLE 601 NFPA CONSTRUCTION TYPE : II (000) TABLE A-8.2.1.2

BUILDING FIRE PROTECTION

AREA SPRINKLERED: FULLY SPRINKLERED FIRE PROTECTION UL DESIGN NUMBERS: _____ O HOUR TYP. COLUMNS FLOOR/BEAM 1 HOUR TYP. BETWEEN FLOOR LEVELS FOR TENANT SEPARATION U.L. D925 ROOF/CEILING O HOUR TYP. GENERAL MATERIALS: EXTERIOR WALLS _____ STUCCO OVER METAL STUDS INTERIOR WALLS _____ GYPSUM BOARD ON METAL STUDS STRUCTURE _____ WIDE FLANGE COLUMNS/ BEAMS _____ COMPOSITE CONCRETE FLOOR DECK FLOOR ROOF MEMBRANE _____ METAL PANEL AND BUILD-UP ROOFING OVER SHEATHING AND

METAL TRUSS FRAMING

BUILDING INFORMATION

FACILITY SIZE:	GROSS SQ FT	LEASABLE SQ FT
1ST FLOOR	20,165 S.F.	17,088 S.F.
2ND FLOOR	20,159 S.F.	16,529 S.F.
3RD FLOOR	20,159 S.F.	16,529 S.F.
4TH FLOOR	20,159 S.F.	16,529 S.F.
5TH LEVEL	19,220 S.F.	15,637 S.F.
TOTALS:	99,862 S.F.	82,312 S.F.


SYMBOL LEGEND

TRAVEL DISTANCE TO AN EXIT	\longrightarrow
TOTAL TRAVEL DISTANCE TO AN EXIT	TD_128
FIRE DEPARTMENT VALVE	FDV
FIRE DEPARTMENT VALVE CABINET	FDVC⊷
FIRE DEPARTMENT VALVE CABINET WITH FIRE EXTINGUISHER	FDVC W/FE
FIRE EXTINGUISHER	FE •
FIRE EXTINGUISHER CABINET	FEC 7
FIRE ALARM CONTROL PANEL	FACP Z
FIRE HOSE CABINET	FHC
FIRE HOSE CABINET WITH FIRE EXTINGUISHER	FHC W/FE
STAND PIPE	SP
PULL STATION	
SMOKE DETECTORS	
AUDIBLE/VISUAL ALARM DEVICE	□◀
VISUAL ONLY ALARM DEVICE	<u></u>
HEAT DETECTION	(H)
SPRINKLER TAMPER SWITCH	TS
SPRINKLER WATERFLOW SWITCH	FS
EXIT LIGHTS	₩ 1

CLEAR WIDTH OF EGRESS DOOR IN INCHES

FIRE WALL LEGEND

NRSTP 1 HR F	(NON-RATED) SMOKE TIGHT PARTITION 1 HOUR FIRE BARRIER
	1 HOUR FIRE/SMOKE BARRIER - COMPARTMENT 1 HOUR FIRE PARTITION - HAZARDOUS/OCCUPANCY
■ ■ ■ 2HR F	2 HOUR FIRE/SMOKE BARRIER - COMPARTMENT
■■ ■ 2HR FS ■■ ■■ ■ ■ 4HR FS ■■	2 HOUR FIRE RATED BARRIER - SHAFT/HAZARDOUS 4 HOUR FIRE/SMOKE WALL

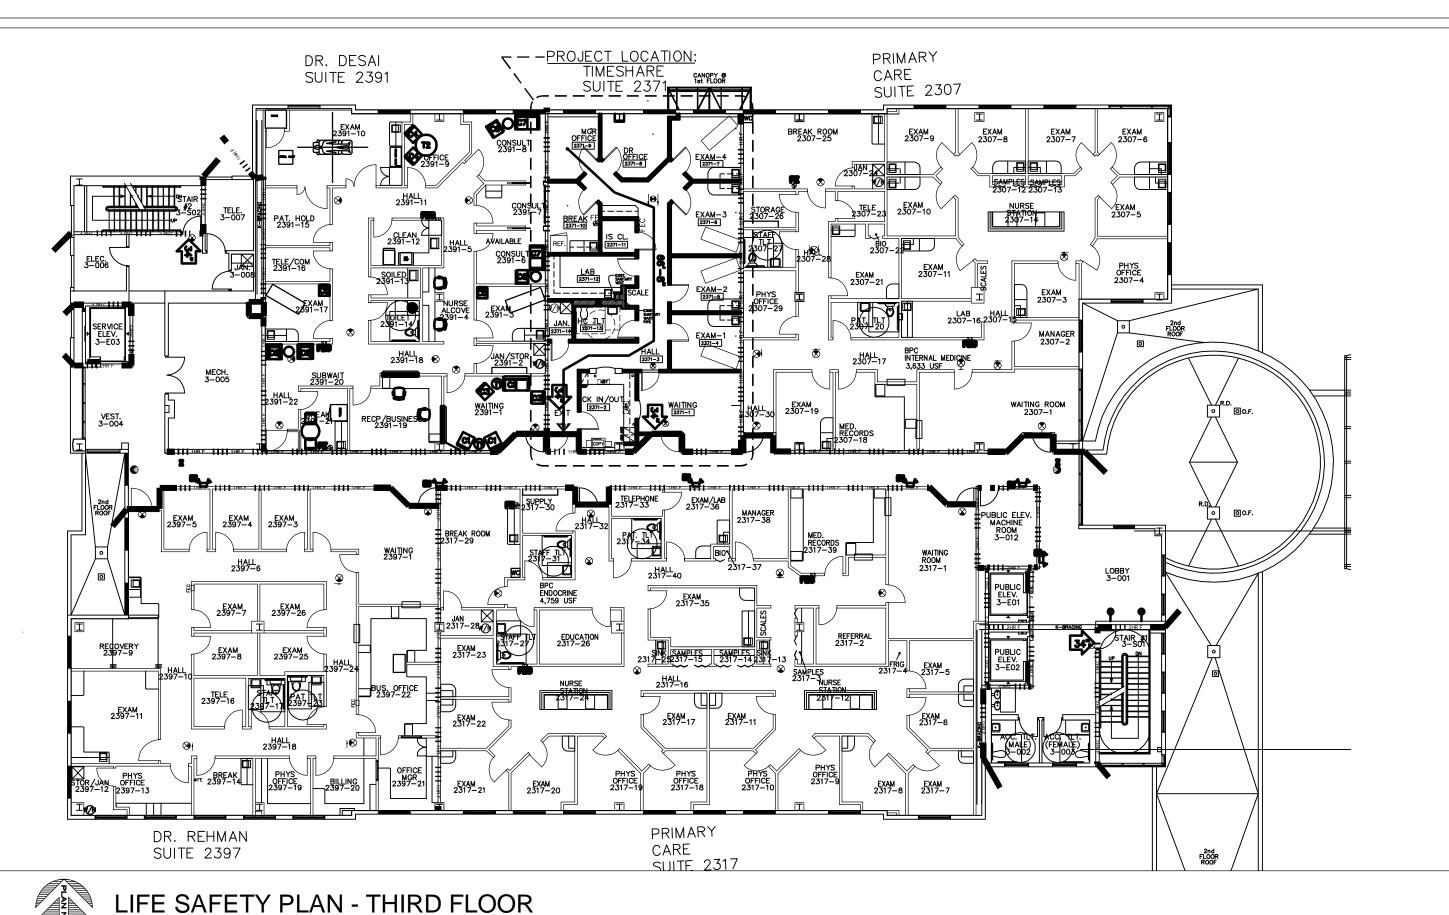

EGRESS CALCULATIONS - EXISTING BUILDING

MEANS OF EGRESS OCC. LOAD 1ST FLOOR 20,165 / 100 = 2022ND FLOOR 20,159 / 100 = 2023RD FLOOR 20,159 / 100 = 2024TH FLOOR 20,159 / 100 = 2025TH LEVEL 19,220 / 100 = 192

TOTAL: EGRESS WIDTH (FIFTH FLOOR)

STAIRWAY (0.3" OCC W/SPRINKLER SYS)

(19'2) (.3) = 57.6" (192) (0.2) = 38.4"

1,000

OTHER COMP. (0.2" OCC W/SPRINKLER SYS)

-DESIGN STAIRWAY WIDTHS ARE 48" @ STAIR #1 AND 42" @ STAIR #2

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EGRESS WIDTH (2ND THROUGH 4TH FLOOR INDIVIDUALLY) STAIRWAY (0.3" OCC W/SPRINKLER SYS)

(202) (.3) = 60.6" OTHER COMP. (0.2" OCC W/SPRINKLER SYS)

(202) (0.2) = 40.4-DESIGN STAIRWAY WIDTHS ARE 48" @ STAIR #1

AND 42" @ STAIR #2 -(2) STAIRS ARE ACCESSIBLE TOTALING 90" > 60.6" -DOORS TO THE STAIRWAY ARE (2) @ 34" CLEAR -(2) DOORS EQUAL 68" > 40.4"

EGRESS WIDTH (GROUND FLOOR / LEVEL OF DISCHARGE) STAIRWAYS = NOT APPLICABLE

202 OCCUPANTS X (0.2 /OCC FOR COMP.)= 40.4" REQUIRED WIDTH

TOTAL =

FIRST LEVEL DOORS PROVIDED = (2 @ 68") + $(1 \otimes 46") + (1 \otimes 34") = 216" > 40.4"$

GROUND LEVEL = 202 OCCUPANTS

CODE SUMMARY

PROJECT DESCRIPTION

THIS PROJECT CONSISTS OF RENOVATING AN EXISTING SHELL SPACE TO PROVIDE A NEW TIMESHARE TENANT SUITE.

PROJECT AREA:

1,894 G.S.F. EXISTING

EXIT CALCULATIONS - TENANT SUITE 2371

(WITH AUTOMATIC SPRINKLER SYSTEM)

AREA SQ. FT. PER SQ. FT. OCCUPANT LOAD				S WIDTH EMENTS	EGRESS PROVIDED (INCHES PER OCCUPANT)		
5Q. FT.	OCCUPANT	207.5	x .2 LEVEL	x .37 STAIR	LEVEL	STAIR	
1,894	100	19	3.8"	7.03"	68"	68"	
1,894		19 people			68"	68"	

SCALE: 1/16" = 1'-0"HANDICAPPED ACCESSIBILITY

PROJECT IS ARCHITECTURALLY BARRIER FREE 100% ACCESSIBLE

APPLICABLE CODES

THIS PROJECT:

- 1. 2007 FLORIDA BUILDING CODE WITH 2009 SUPPLEMENTS.
- 2. 2004 FLORIDA BUILDING CODE: EXISTING BUILDING, INCLUDES 2006
- 3. 2007 FLORIDA PLUMBING CODE WITH 2009 SUPPLEMENTS.
- 4. 2007 FLORIDA MECHANICAL CODE WITH 2009 SUPPLEMENTS.
- FLORIDA EDITION OF THE NATIONAL FIRE PROTECTION ASSOCIATION (NFPA) 101 LIFE SAFETY CODE, 2006 EDITION OF THE FLORIDA FIRE PREVENTION CODE.
- 6. NFPA 220, STANDARD ON TYPES OF BUILDING CONSTRUCTION.
- 7. NFPA 221, STANDARD FOR FIRE WALLS AND FIRE BARRIER WALLS.
- 8. 2007 EDITION FLORIDA BUILDING CODE CHAPTER 11 ACCESSIBILITY

BUILDING CLASSIFICATION

OCCUPANCY TYPE: BUSINESS

FBC OCCUPANCY GROUP B: PROFESSIONAL SERVICE

CONSTRUCTION TYPE:

FBC CONSTRUCTION TYPE II B, SECTION 602, 2006 EDITION AND TABLE 601 NFPA CONSTRUCTION TYPE : II (000) TABLE A-8.2.1.2

BUILDING INFORMATION

BUILDING FIRE PROTECTION

O HOUR TYP.

U.L. D925

0 HOUR TYP.

_____ WIDE FLANGE COLUMNS/ BEAMS

_____ COMPOSITE CONCRETE FLOOR DECK

METAL TRUSS FRAMING

ROOFING OVER SHEATHING AND

1 HOUR TYP. BETWEEN FLOOR

LEVELS FOR TENANT SEPARATION

AREA SPRINKLERED: FULLY SPRINKLERED

FIRE PROTECTION UL DESIGN NUMBERS:

COLUMNS

FLOOR/BEAM

ROOF/CEILING

GENERAL MATERIALS:

STRUCTURE

FLOOR

FACILITY SIZE:	GROSS SQ FT	LEASABLE SQ FT
1ST FLOOR	20,165 S.F.	17,088 S.F.
2ND FLOOR	20,159 S.F.	16,529 S.F.
3RD FLOOR	20,159 S.F.	16,529 S.F.
4TH FLOOR	20,159 S.F.	16,529 S.F.
5TH LEVEL	19,220 S.F.	15,637 S.F.
TOTALS:	99,862 S.F.	82,312 S.F.

EXTERIOR WALLS _____ STUCCO OVER METAL STUDS

ROOF MEMBRANE _____ METAL PANEL AND BUILD-UP

INTERIOR WALLS _____ GYPSUM BOARD ON METAL STUDS

FIRE WALL LEGEND

NOTE: REFER TO SHEET AL100 FOR SYMBOL LEGEND.

NRSTP ■	(NON-RATED) SMOKE TIGHT PARTITION 1 HOUR FIRE BARRIER
THR FS 1HR FS 1HR FS	1 HOUR FIRE/SMOKE BARRIER - COMPARTMENT
1HRHZ 1HRHZ 1HRHZ 1HRHZ 1HRHZ 1HRHZ 1HRHZ	1 HOUR FIRE PARTITION - HAZARDOUS/OCCUPANCY
■ 2HR F 2HR F 2HR F 2HR F 2HR F 2HR F	2 HOUR FIRE/SMOKE BARRIER - COMPARTMENT
	2 HOUR FIRE RATED BARRIER — SHAFT/HAZARDOUS
4HR FS 4HR FS 4HR FS 4HR FS	4 HOUR FIRE/SMOKE WALL

STENCIL ALL PARTITIONS WITHIN THE AREA OF CONSTRUCTION. MAXIMUM SPACING 20'-0". BOTH SIDES OF PARTITION AND EACH WALL SEGMENT. REFER TO BHS STENCILING REQUIREMENTS.

ISSUE DATE: NOVEMBER 09, 201 ISSUE: PERMIT

DRAWN BY: AJB, NDJ, JRD CHECKED BY: AJB

DATE REVISION



SOUTH

BAPTIST MEDICAL CENTER INTERSTATE 95 EXIT 335 14550 OLD ST. AUGUSTINE ROAD JACKSONVILLE, FLORIDA 32258

CREATE TIMESHARE OFFICE WITH FURNITURE MOB2 SUITE #2371

<u>THIRD FLOOR</u>

LIFE SAFETY PLAN, CODE SUMMARY

SCALE:AS NOTED

LOG NO. T:\Baptist Health...\Drawings


C & A FN: 3943

Est. Project GSF: 1,894

BOMA SF: 1,792


SHEET NUMBER: **AL300**

3 OF 16

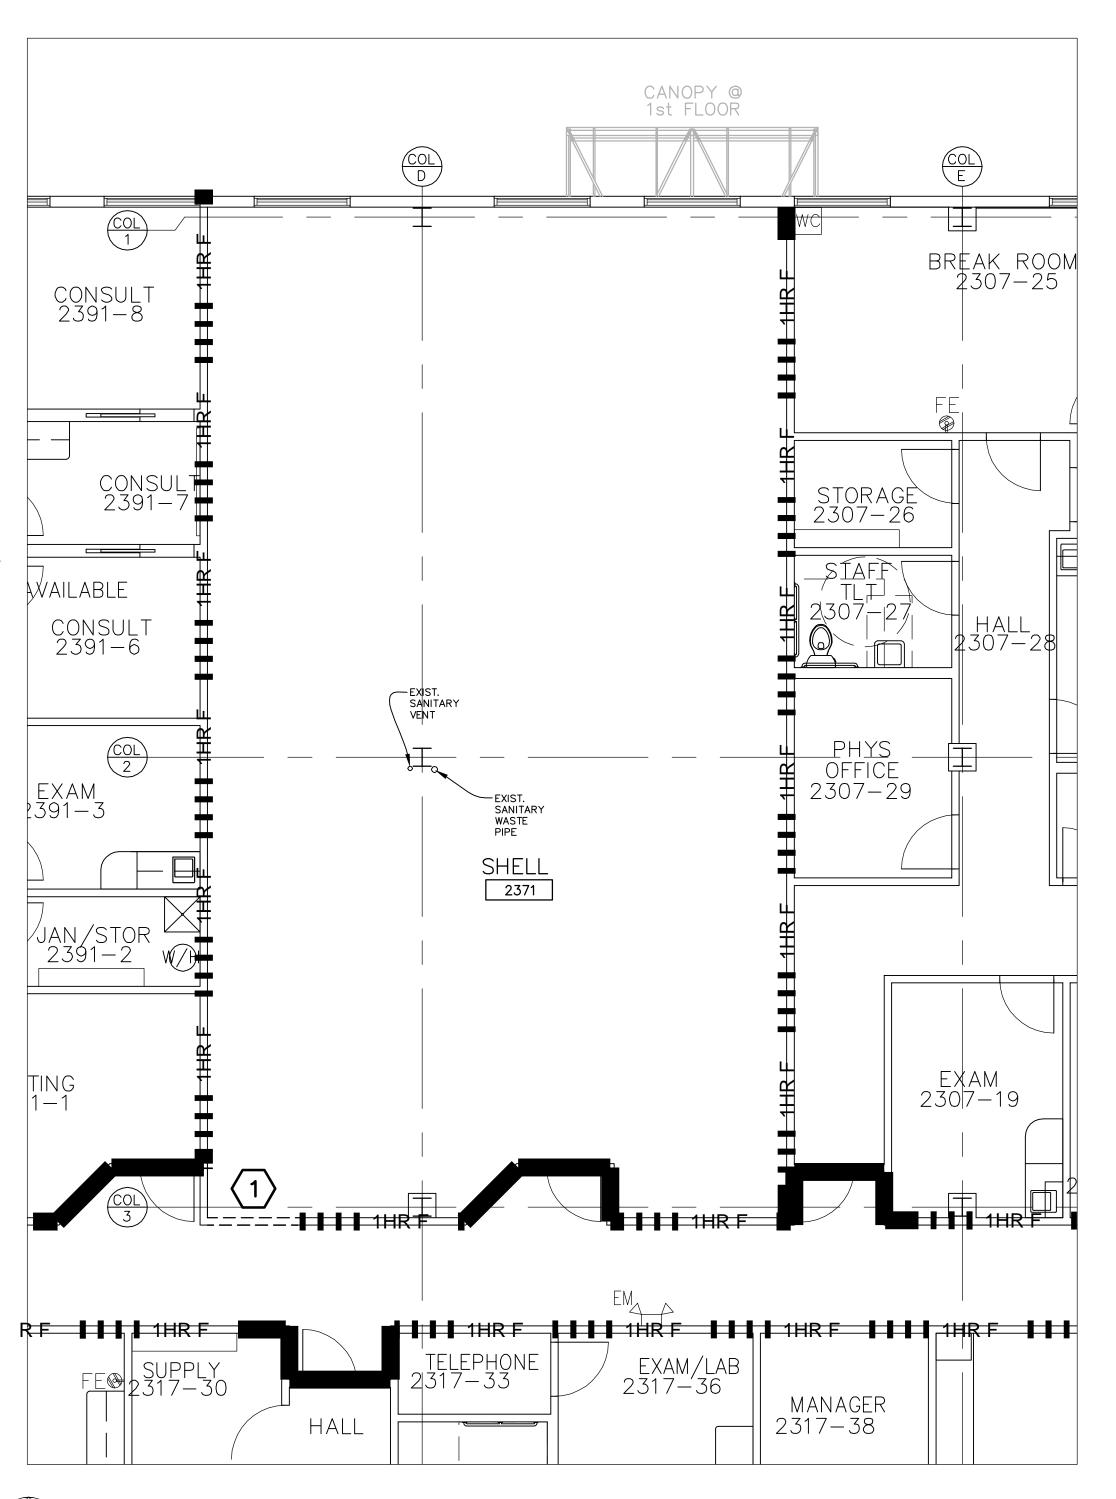

GENERAL DEMOLITION NOTES

- A. DRAWINGS DO NOT NECESSARILY REFLECT EXACT FIELD CONDITIONS. CONTRACTORS SHALL FAMILIARIZE THEMSELVES WITH EXISTING CONDITIONS PRIOR TO BIDDING. PROJECT TO BE COMPLETED IN ONE PHASE.
- B. EXISTING WALL MOUNTED ELECTRICAL OUTLETS, DATA, ETC. ARE NOT SHOWN ON DEMOLITION PLAN. ALL TO REMAIN UNLESS NOTED OTHERWISE.
- C. REMOVE ALL EXISTING FINISHES IN AREAS WHERE INDICATED AS NEW ON FINISH
- D. REPAIR ALL EXISTING FINISHES AND CLOSE OFF ALL PENETRATIONS CREATED BY THE REMOVAL OF EXISTING PLUMBING, CONDUIT, DUCTWORK, ETC. OR OTHERWISE DAMAGED
- E. THE ASSIGNED CONTRACTOR IS TO REPAIR WALLS TO REMAIN. INCLUDED IN THE CONTRACTOR'S SCOPE OF WORK IS TO INSPECT EXISTING FIREWALLS & SMOKE TIGHT WALL, AND BRING THEM TO CODE COMPLIANCE. THIS INCLUDES PATCHING HOLES, FIRE CAULKING AND PROPER STENCILING.
- F. THE ASSIGNED CONTRACTOR SHALL POST "CONSTRUCTION SITE THEFT WARNING" SIGN ON JOBSITE, AT ALL TIMES, AND AT EACH AREA OF WORK. CONTACT PROJECT MANAGER FOR SIGNAGE.
- G. ANY DISCREPANCIES BETWEEN PLANS, ELEVATIONS, SECTIONS, ETC. SHALL BE ADDRESSED WITH PROJECT MANAGER, INTERIOR DESIGNER, ARCHITECT PRIOR TO STARTING OF ANY WORK.

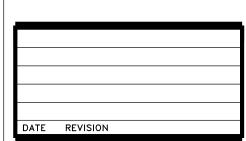

ISSUE DATE: NOVEMBER 09, 2011 ISSUE: PERMIT

DRAWN BY: AJB, NDJ, JRD CHECKED BY: AJB

DEMOLITION PLAN LEGEND

EXISTING TO REMAIN

REMOVE EXISTING WALLS, DOORS, MILLWORK, EQUIPMENT, ETC. SHOWN AS DASHED.

■ ■ ■ ■ 1 HR F ■ 1 HOUR FIRE WALL/TENANT SEPARATION PARTITION

KEYED DEMOLITION NOTES

UNLESS OTHERWISE NOTED, THE CONTRACTOR SHALL PERFORM THE FOLLOWING ITEMS/TASKS.

(1) REMOVE A PORTION OF THE WALL FOR NEW DOOR, FRAME, & HARDWARE.



SOUTH


BAPTIST MEDICAL CENTER INTERSTATE 95 EXIT 335 14550 OLD ST. AUGUSTINE ROAD JACKSONVILLE, FLORIDA 32258

CREATE TIMESHARE OFFICE WITH FURNITURE MOB2 SUITE #2371

THIRD FLOOR

DEMOLITION PLAN, GENERAL NOTES, KEYED NOTES

KEY PLAN

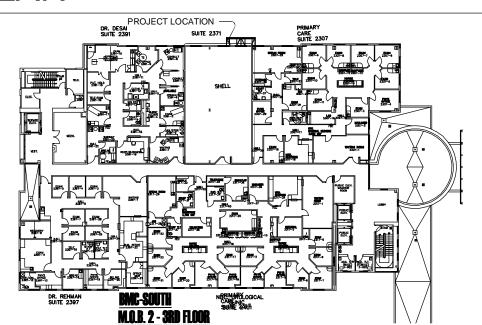

SCALE: AS NOTED

LOG NO. T:\Baptist Health...\Drawings\


C & A FN: 3943

Est. Project GSF: 1,894

BOMA SF: 1,792

SHEET NUMBER: A101 4 OF 16

DEMOLITION PLAN - THIRD FLOOR SCALE: 3/16" = 1'-0"

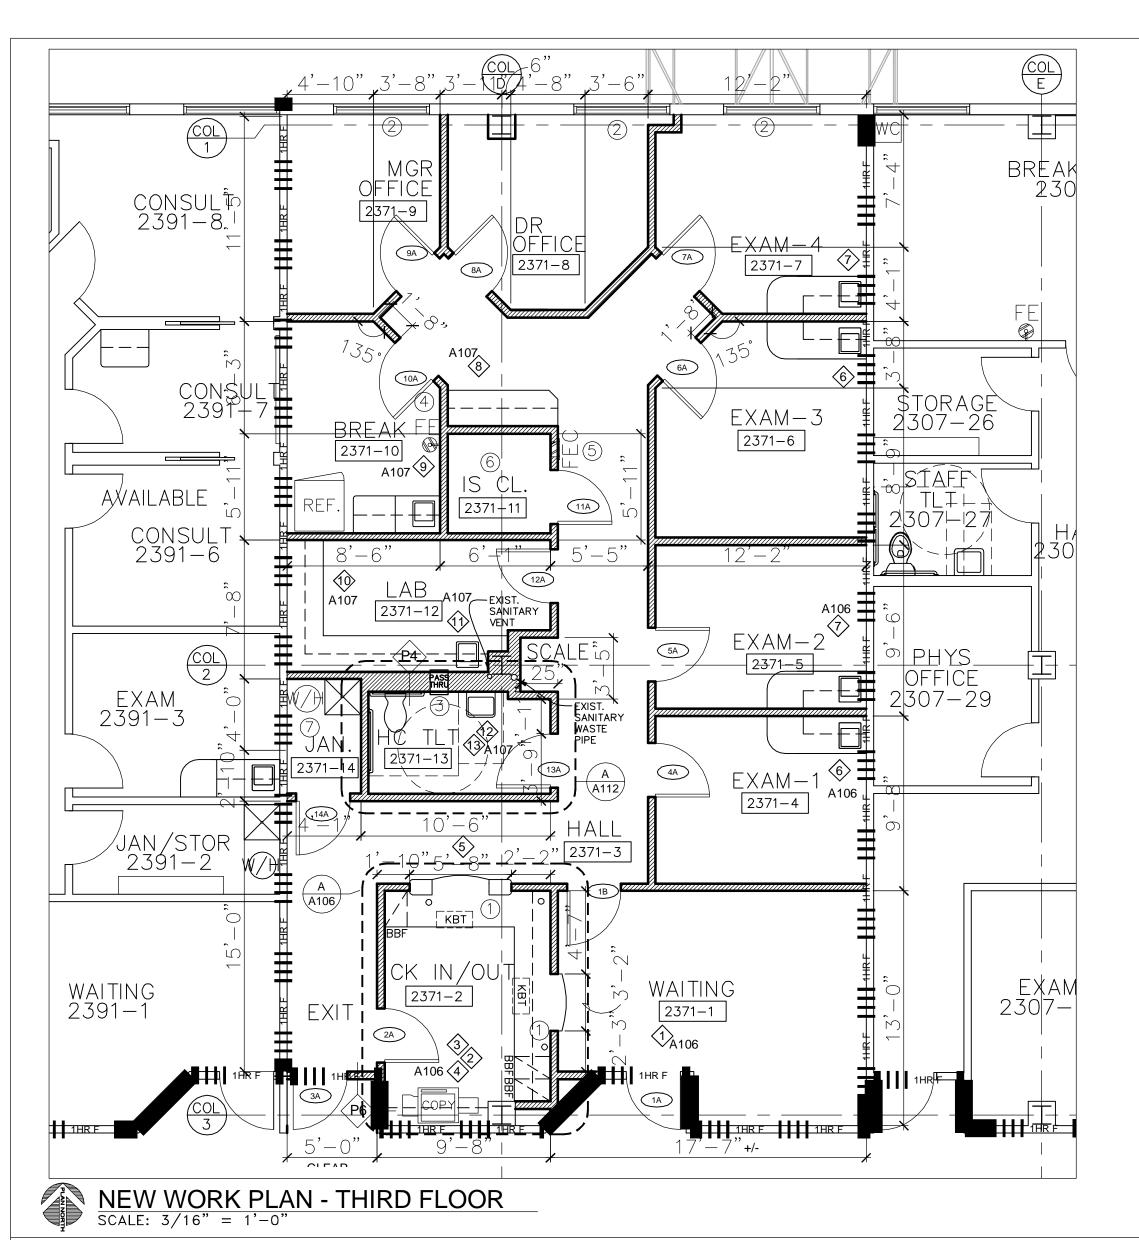

GENERAL NEW WORK NOTES

- A. GENERAL CONTRACTOR SHALL MAINTAIN BUILDING SECURITY, FIRE ALARM AND PROTECTION AT ALL TIMES DURING PERFORMANCE OF WORK.
- B. CONTRACTOR TO PROVIDE WOOD BLOCKING AND STEEL SUPPORTS WITHIN ALL NEW OR REWORKED PARTITIONS TO ACCOMMODATE ANY AND ALL ATTACHED FIXTURES INCLUDING (BUT NOT LIMITED TO) MILLWORK, SHELVING, GLAZING, PENDANT FIXTURES, ETC.. ALL BLOCKING WITHIN PARTITIONS SHALL BE OF FIRE RETARDING MATERIAL.
- C. PATCH AND REPAIR ALL GYPSUM BOARD WALL SURFACES SHOWN TO REMAIN AND AFFECTED BY NEW CONSTRUCTION WITH MATERIALS AND METHODS TO MATCH EXISTING CONDITIONS AND PROVIDE A UNIFORM APPEARANCE. PREPARE GYPSUM BOARD TO RECEIVE NEW WALL FINISHES (TO CEILING HEIGHT) AS SPECIFIED.
- D. NOTE ALL NEW PARTITIONS TO USE 3-5/8" MTL. STUDS, 25 ga.

 @ 16" O.C. AND 3-1/2" SOUND BATT INSULATION WITH 5/8" GWB
 EACH SIDE, UNLESS OTHERWISE NOTED.
- E. ANY NOTES STATING "TENANT/BUILDING STANDARDS", REFER TO BMC PROPERTY MANAGEMENT'S SPEC GUIDE FOR APPROPRIATE INFORMATION. CONTACT WENDY RICHARDSON AT 904-202-4990.

- F. PROVIDE AND INSTALL FOAM SOAP AND TOWEL DISPENSERS AT ALL SINKS.
 IN ADDITION, AT RESTROOMS, PROVIDE AND INSTALL TOILET PAPER
 DISPENSER, STAINLESS FRAMED MIRROR AT SINK AND TOILET GRAB BARS AS
 SHOWN ON NEW WORK PLAN AND IN ACCORDANCE WITH ADA CODES.
 PROVIDE APPROPRIATE SUPPORT BACKING IN WALLS.
- G. CONTACT PROJECT MANAGER SEVEN (7) BUSINESS DAYS PRIOR TO SHUTTING OFF WATER, SEWER, PLUMBING, ELECTRICAL AND ALL OTHER BUILDING SYSTEMS FOR DEMOLITION AND NEW WORK.
- H. PARTITION TYPE "P1" TYPICAL U.N.O.
- I. REFER TO MEP & FIRE PROTECTION DRAWINGS FOR ADDITIONAL INFORMATION.
- J. PROVIDE AND INSTALL NEW TENANT/BUILDING STANDARD SIGNAGE AT ALL ENTRY DOORS, COORDINATE EXACT VERBIAGE WITH PROJECT MANAGER. FOR SIGNS AT INTERIOR SUITE, CONTACT PROPERTY MANAGEMENT.
- K. CONTRACTOR TO COMPLY WITH THE APPROVED & SIGNED INFECTION CONTROL PERMIT (BY INFECTION CONTROL), ICRA POLICY & PROCEDURES FOR TYPE II CONSTRUCTION BARRIERS FOR TYPE C/D CONSTRUCTION ACTIVITY IN BUSINESS OCCUPANCY. THIS INCLUDES ALL THE REQUIREMENTS FOR CLASS I.

KEYED NEW WORK NOTES

UNLESS OTHERWISE NOTED, <u>THE CONTRACTOR SHALL PERFORM THE</u> <u>FOLLOWING ITEMS/TASKS:</u>

- 1 PROVIDE AND INSTALL NEW QUADPLEX & DUPLEX UNDER NEW COUNTERTOP. COORDINATE WITH ELECTRICAL ENGINEERING DRAWINGS.
- 2 PROVIDE AND INSTALL NEW MINI-BLINDS AT EXTERIOR WINDOWS. MATCH BUILDING STANDARD FOR CONSISTENCY.
- 3 PROVIDE AND INSTALL NEW MILLWORK SPECIMEN PASS-THROUGH CABINET.
- (4) FIRE EXTINGUISHER ON WALL MOUNTED BRACKET
- (5) FIRE EXTINGUISHER. PROVIDE AND INSTALL IN CABINET
- 6 PROVIDE & INSTALL ¼" PLYWOOD BACKBOARD FOR MOUNTING IS/TELECOM EQUIPMENT.
- (7) WATER HEATER & JANITOR FLOOR MOP SINK. SEE PLUMBING DRAWING.

DATE REVISION

ENERGY SAVINGS:

- 1. <u>T8 LIGHTING FIXTURES</u>: WE ARE PROVIDING T8 LIGHT FIXTURES, INSTEAD OF T12, AT THE SUITE. THIS WILL SAVE APPROXIMATELY \$238/YEAR WITH AN ROI OF 21.6%
- 2. <u>WATER EFFICIENT PLUMBING FIXTURES</u>: WE ARE PROVIDING A NEW WATER EFFICIENT TOILET AT THE NEW UNISEX ADA TOILET ROOM, SAVING APPROXIMATELY \$50-\$100 PFR YFAR PFR TOILET.
- 3. <u>LOW FLOW FAUCETS</u>: WE ARE PROVIDING LOW FLOW FAUCETS AT THE NEW UNISEX ADA TOILET ROOM, SAVING APPROXIMATELY \$150 PER YEAR PER FAUCET. WITH AN ROL OF 62.9%.

TENANT RESPONSIBILITIES:

THE TENANT IS RESPONSIBLE FOR ACQUIRING, INSTALLING AND/OR RELOCATING THE FOLLOWING ITEMS/SYSTEMS VIA THEMSELVES OR THEIR CONSULTANT OR VENDOR:

- 1. ALL DATA AND TELEPHONE WIRING AND EQUIPMENT.
- 2. ALL SPEAKER/MUSIC WIRING AND EQUIPMENT.
- 3. ALL EQUIPMENT RELOCATED, INSTALLED AND CALIBRATED BY TENANT'S CONSULTANT/VENDOR.
- 4. EXPEDITOR SIGNALING SYSTEM.
- 5. MUSIC SYSTEM.

PLANS PROVIDED ARE FOR REFERENCE ONLY. ARCHITECT/INTERIOR DESIGNER/PROJECT MANAGER NOT RESPONSIBLE FOR TENANT'S CONSULTANT FIELD VERIFICATION AND FINAL LOCATION.

NEW WORK PLAN LEGEND


1HR F

1 HOUR RATED FIRE WALL/TENANT SEPERATION

EXISTING TO REMAIN
NEW WALL CONSTRUCTION

REFER TO ELECTRICAL ENGINEERING DRAWINGS FOR LOCATIONS OF POWER & DATA OUTLETS.

KEY PLAN

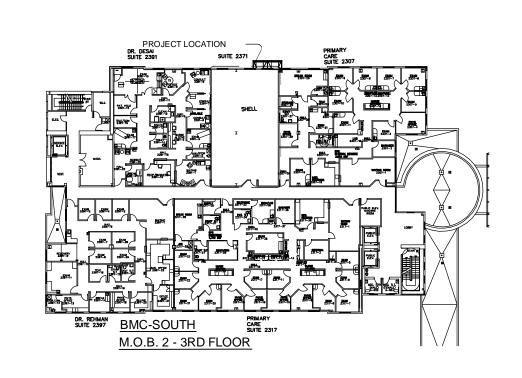

ISSUE DATE: NOVEMBER 09, 2011
ISSUE: PERMIT

DRAWN BY: AJB, NDJ, JRD CHECKED BY: AJB



SOUTH

BAPTIST MEDICAL CENTER INTERSTATE 95 EXIT 335 14550 OLD ST. AUGUSTINE ROAD JACKSONVILLE, FLORIDA 32258

CREATE TIMESHARE
OFFICE WITH FURNITURE
MOB2 SUITE #2371

SHEET NAME

THIRD FLOOR

NEW WORK PLAN, GENERAL NOTES, KEYED NOTES

SCALE: AS NOTED

LOG NO. T:\Baptist Health...\Drawings\


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A 1 0 2


5 OF 16



KEYED FURNITURE NOTES

EXACT FURNITURE SPECIFICATIONS TO BE PREPARED BY BMC INTERIOR DESIGN. A BUDGET OF \$19,500.00 HAS BEEN ESTABLISHED AND SHALL BE INCLUDED IN THE C&A OVERALL PROJECT TOTAL BASED ON THE QUANTITIES AND DESCRIPTIONS BELOW.

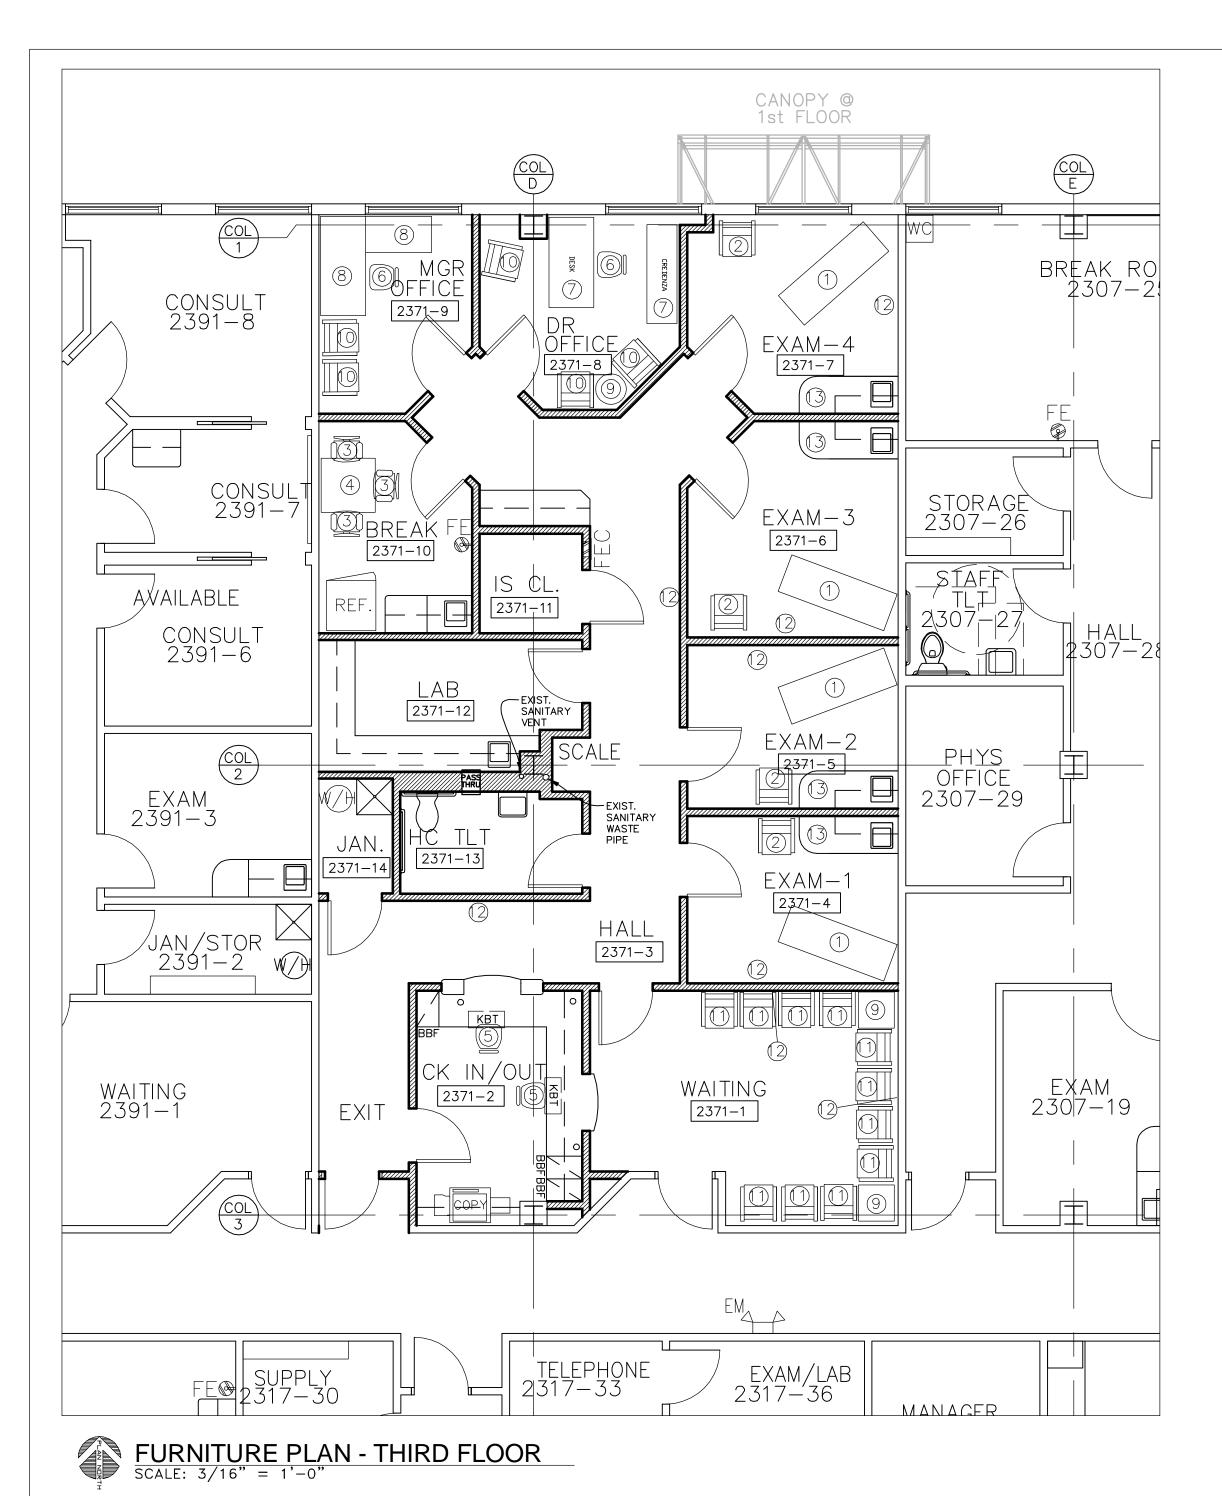- 1 EXAM TABLE
- (2) SIDE GUEST CHAIR WITH PADDED SEAT
- 3 PLASTIC MOLDED CHAIR
- (4) 36" SQUARE PLASTIC LAMINATE TABLE
- (5) OPERATIONAL TASK CHAIR
- (6) OFFICE TASK CHAIR
- (7) DESK WITH CREDENZA
- (8) RIGHT RETURN L SHAPED DESK
- (9) WOOD END TABLE WITH LAMINATE TOP
- (0) GUEST CHAIR METAL LEGS UPHOLSTERED SEAT/BACK
- (1) WAITING CHAIR WOOD LEGS UPHOLSTERED SEAT/BACK
- (2) FRAMED ARTWORK
- (3) PHYSICIAN EXAM STOOL

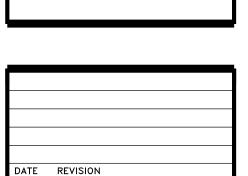

ISSUE DATE: NOVEMBER 09, 2011
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SOUTH

BAPTIST MEDICAL CENTER INTERSTATE 95 EXIT 335 14550 OLD ST. AUGUSTINE ROAD JACKSONVILLE, FLORIDA 32258


CREATE TIMESHARE
OFFICE WITH FURNITURE
MOB2 SUITE #2371

SHEET NAME:

THIRD FLOOR

FURNITURE PLAN

KEY PLAN

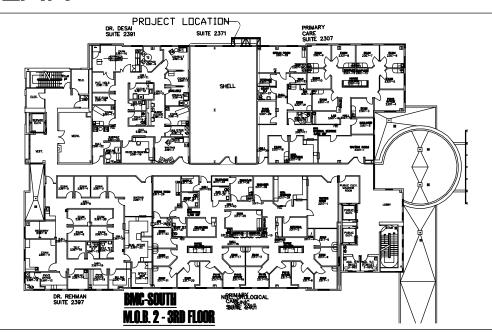

SCALE: AS NOTED


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C & A FN: 3943

Est. Project GSF: 1,894

BOMA SF: 1,792

A 103



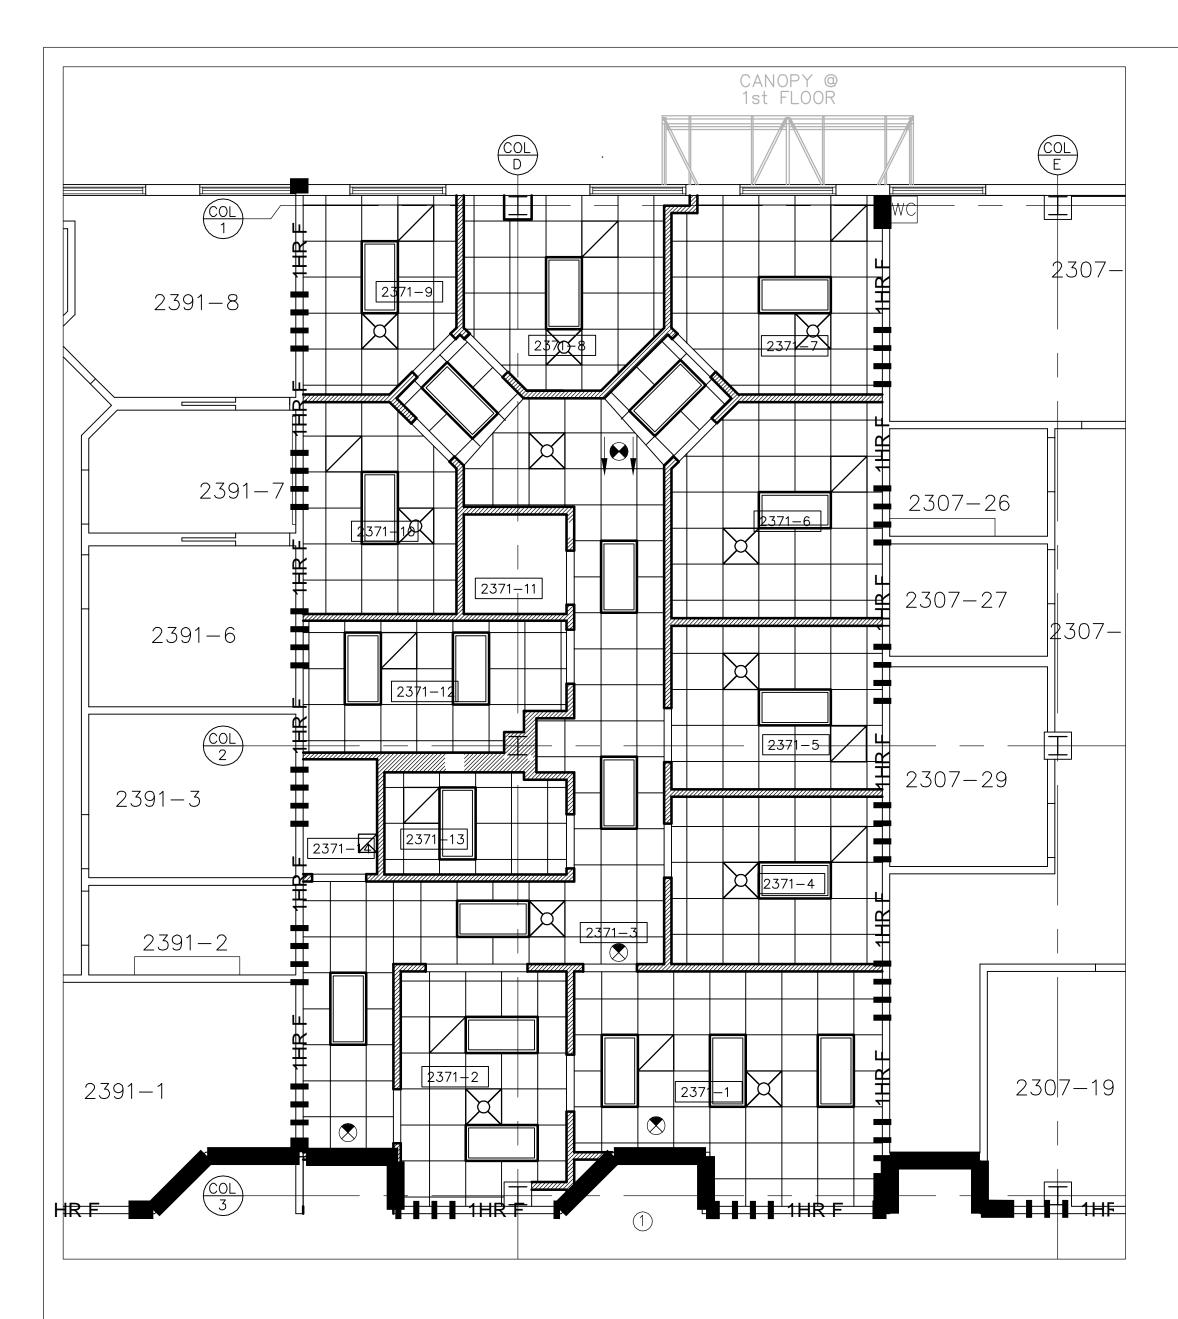

REFLECTED CEILING PLAN - THIRD FLOOR SCALE: 3/16" = 1'-0"

KEYED NOTE

UNLESS OTHERWISE NOTED, THE CONTRACTOR SHALL PERFORM THE FOLLOWING ITEMS/TASKS:

(1) PROVIDE AND INSTALL ACOUSTICAL CEILING TILE AND GRID AS NEEDED/REQUIRED FOR HVAC/ELECTRICAL/PLUMBING FIRE PROTECTION DEMO/NEW WORK.

LEGEND

EXIT SIGN, MATCH BUILDING STANDARD

SUPPLY DIFFUSER (SEE MECH. SHEETS)

RETURN AIR GRILLE (SEE MECH. SHEETS)

RECESSED DOWN LIGHT (SEE ELECT. SHEETS)

RECESSED 2 X 4 FLOURESCENT LIGHT FIXTURE (SEE ELECT. SHEETS)

RECESSED 2 X 2 FLOURESCENT LIGHT FIXTURE (SEE ELECT. SHEETS)

GENERAL NOTES

A. PROVIDE ROLL SOUND ATTENUATING BLANKETS AT EXAM ROOMS, TOILET ROOMS, PHYSCIANS' OFFICES, BUT DO NOT APPLY OVER LIGHT FIXTURES.

B. UNLESS NOTED OTHERWISE, ALL CEILING HEIGHTS TO BE 9'-0" A.F.F.

C. REFER TO & COORDINATE WITH MECHANICAL, ELECTRICAL, PLUMBING & FIRE PROTECTION DRAWINGS.

D. ALL NEW GRIDS TO BE CENTERED IN ROOM U.N.O.

E. ALL NEW CEILING TILES SHALL BE NOT LESS THAN 3" MIN. IN WIDTH.

F. ALL SPRINKLER HEADS SHALL BE CENTERED IN TILE U.N.O.

G. NEW CEILING TILE TO BE:

1. MANUFACTURER: ARMSTRONG

2. MODEL NO.: 756A 3. COLOR: WHITE

4. SIZE: 2' X 2' X 5%" 5. PATTERN: FINE FISSURED

6. EDGE/JOINT DETAIL: SQUARE

H. NEW CEILING GRID TO BE:

7. MANUFACTURER: ARMSTRONG 8. MODEL: PRELUDE XL 9. COLOR: WHITE

11. STRUCTURAL CLASSIFICATION: INTERMEDIATE-DUTY SYSTEM

I. EXISTING FIRE PROTECTION SYSTEM: THE CONTRACTOR SHALL MODIFY/ADD TO/RELOCATE/EXTEND THE EXISTING SYSTEM/SPRINKLER HEADS TO ACHIEVE COVERAGE FOR NEW DESIGN AND MEET CODES. REFER TO ENGINEERING DRAWINGS. THE CONTRACTOR SHALL INSTALL SUFFICIENT HEADS IN SPACES TO PROVIDE COMPLETE (100%) AUTOMATIC SPRINKLER COVERAGE PER NFPA 13, THE FIRE PROTECTION DRAWINGS AND AS REQUIRED BY THE OWNER'S INSURANCE UNDERWRITER, AND SHALL REPORT TO THE PROJECT MANAGER/ENGINEER ANY ERROR, INCONSISTENCY OR OMISSION THAT HE MIGHT DISCOVER.

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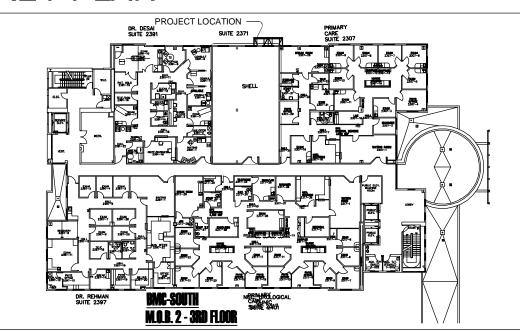
CREATE TIMESHARE OFFICE WITH FURNITURE MOB2 SUITE #2371

SHEET NAME:

THIRD FLOOR

REFLECTED CEILING PLAN

KEY PLAN



SCALE: AS NOTED

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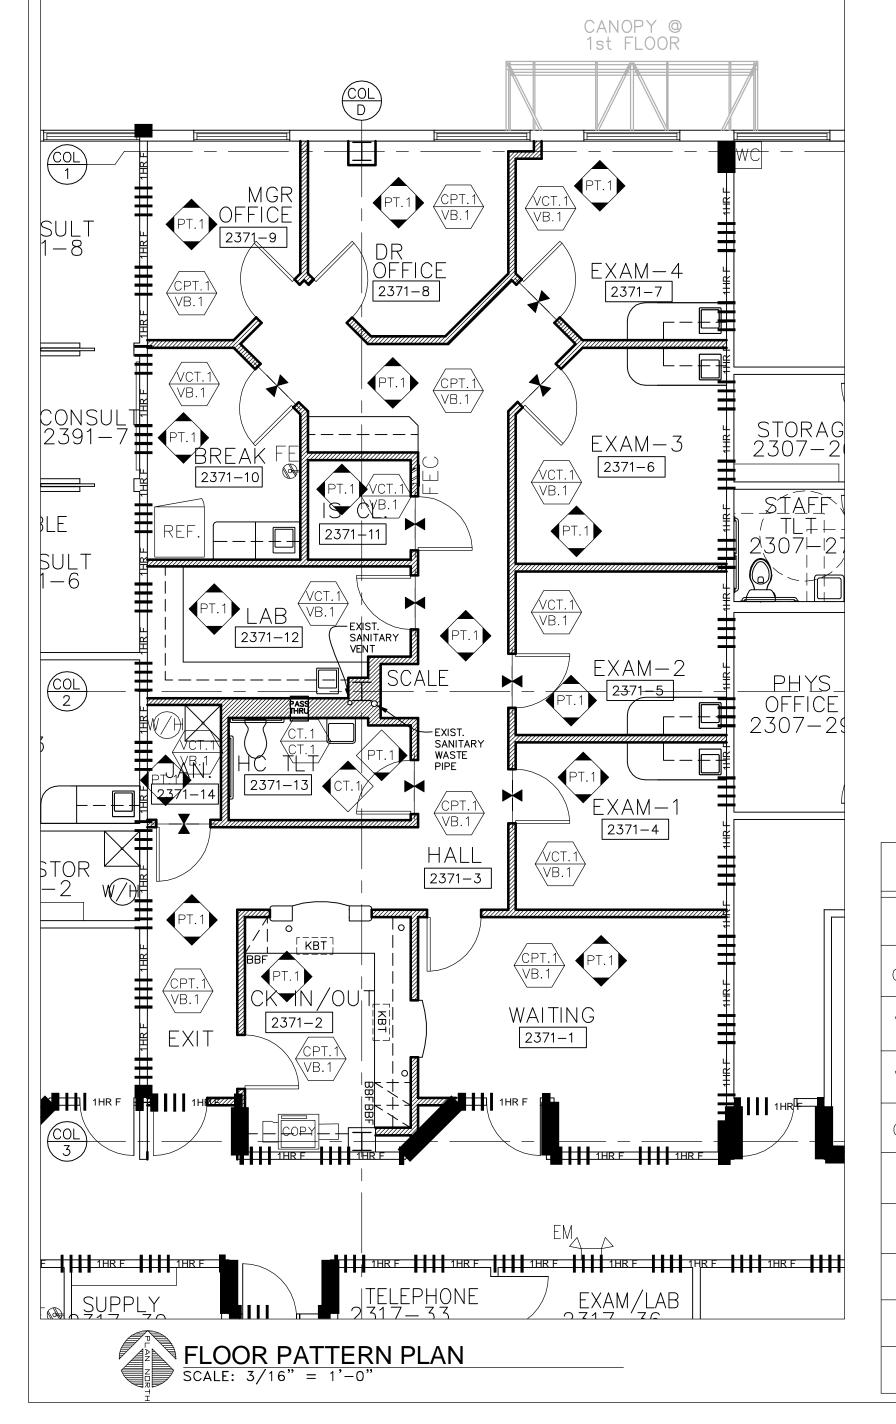
C & A FN: 3943

Est. Project GSF: 1,894

BOMA SF: 1,792

SHEET NUMBER: A104

7 OF 16



GENERAL FINISHES NOTES

- A. REMOVE EXISTING FINISHES IN AREAS WHERE INDICATED AS NEW ON FINISH SCHEDULE (THIS SHEET).
- B. REMOVE EXISTING WALLCOVERING THROUGHOUT. SKIM COAT WALLS & PREPARE FOR PAINT, WHERE INDICATED.
- C. PAINT ALL METAL DOOR FRAMES, ACCESS PANELS, FIRE EXTINGUISHER BOXES, ETC. TO MATCH ADJACENT WALL PAINT COLOR. USE PT.1
- D. CHANGE IN FLOORING FINISH TRANSITION SHALL BE IN CENTER OF ROOM DOOR OPENING, UNLESS OTHER NOTED OR INDICATED ON FLOORING PLAN.
- E. DO NOT CHECKERBOARD VCT TILES.
- F. ALL MILLWORK CABINETS (UPPERS/LOWERS) SHALL BE: PL.1, ALL COUNTERTOPS/BACKSPLASH SHALL BE: PL.2
- G. DO NOT PAINT OVER FIRE-RATED LABELS/TAGS/EMBOSSING ON DOOR FRAMES OR ON DOORS.
- H. A PRIMER AND 2 COATS OF BMC STANDARD PAINTS TO COVER ALL WALL SURFACES, DOOR FRAMES (SEE NOTE 'G' ABOVE) AND HARD CEILINGS.

FINISHES SYMBOL LEGEND



FLOOR AND BASE FINISH



WALL FINISH



THANGE IN FLOOR FINISH

ISSUE DATE: NOVEMBER 09, 2011

DATE REVISION

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CREATE TIMESHARE
OFFICE WITH FURNITURE
MOB2 SUITE #2371

FINISH LEGEND									
ITEM	DESCRIPTION	MANUFACTURER	PATTERN/ NUMBER	COLOR	SIZE	REMARKS			
CPT-1	CARPET	BIGELOW	BC290-7988 PLAY HARD	RECHARGE OFTEN					
VCT-1	VINYL COMPOSITION TILE	MANNINGTON ESSENTIALS	143	FLAX	12"x12"				
VB-1	VINYL BASE	JOHNSONITE	TRADITIONAL	47 C-BROWN	4" HIGH				
CT-1	CERAMIC TILE	TRINITY	GALLERY	ZINC WHITE	12"x12"	GROUT SHALL BE: MAPEI, 39 IVORY			
PT-1	PAINT	ICI	#40YY 44/095	A1852 DRY GOODS		EGGSHELL FINISH FOR WALLS, SEMI GLOSS FOR DOOR FRAMES/METAL SURFACES			
PL-1	PLASTIC LAMINATE	WILSONART	7953-38	HARVEST MAPLE		(VERTICAL SURFACES) CABINETS & DOORS			
PL-2	PLASTIC LAMINATE	NEVAMAR	MR2007T	BRONZE MATRIX		(HORIZONTAL SURFACES) COUNTERTOP			
	1	1			1				

FINISH DISTRIBUTION
PLAN AND LEGEND

SCALE: AS NOTED

LOG NO. T:\Baptist Health...\Drawings\

C & A FN: 3943

Est. Project GSF: 1,894

BOMA SF: 1,792

SHEET NUMBER:
A105

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	DOOR SCHEDULE								
DOOR SYM.	DOOR SIZE	DOOR TYPE	DOOR MATERIAL	FRAME TYPE	FRAME MATERIAL	HW SET	JAMB DETAIL	LABEL	REMARKS
1A	EXISTING							20 MIN.	
1B	3'-0" X 7'-0" X 1 3/4"	А	S.C.W.	1	H.M.	2	1/A105		
2A	3'-0" X 7'-0" X 1 3/4"	Α	S.C.W.	1	H.M.	2	1/A105		
3A	3'-0" X 7'-0" X 1 3/4"	В	S.C.W.	2	H.M.	1	1/A105	20 MIN.	
4A	3'-0" X 7'-0" X 1 3/4"	Α	S.C.W.	1	H.M.	4	1/A105		
5A	3'-0" X 7'-0" X 1 3/4"	А	S.C.W.	1	H.M.	4	1/A105		
6A	3'-0" X 7'-0" X 1 3/4"	Α	S.C.W.	1	H.M.	4	1/A105		
7A	3'-0" X 7'-0" X 1 3/4"	Α	S.C.W.	1	H.M.	4	1/A105		
88	3'-0" X 7'-0" X 1 3/4"	А	S.C.W.	1	H.M.	2	1/A105		
9A	3'-0" X 7'-0" X 1 3/4"	Α	S.C.W.	1	H.M.	2	1/A105		
10A	3'-0" X 7'-0" X 1 3/4"	А	S.C.W.	1	H.M.	6	1/A105		
11A	3'-0" X 7'-0" X 1 3/4"	Α	S.C.W.	1	H.M.	5	1/A105		
12A	3'-0" X 7'-0" X 1 3/4"	А	S.C.W.	1	H.M.	2	1/A105		
13A	3'-0" X 7'-0" X 1 3/4"	А	S.C.W.	1	H.M.	3	1/A105		
14A	3'-0" X 7'-0" X 1 3/4"	А	S.C.W.	1	H.M.	5	1/A105		

DOOR SCHEDULE NOTES

- 1. ALL HARDWARE SHALL MATCH BUILDING STANDARDS, COMPLYING WITH ADA HANDICAPPED ACCESSIBLITY CODES. KEY LOCKSETS (NEW AND EXISTING) SHALL BE COMPATIBLE WITH BUILDING MASTER KEY.
- 2. DO NOT PAINT OVER FIRE-RATED LABELS/TAGS/EMBOSSING ON DOOR FRAMES OR ON DOORS.

HARDWARE:

GROL	GROUP 1 - 20 MIN.									
SING	SINGLE ENTRY DOOR TO SUITE/CORRIDOR									
3	HINGES	T4A3386	4.5 x 4.5							
1	LOCKSET	AU5407LN			ENTRY FUNCTION					
1	CLOSER	3501		DL						
1	STOP	WS03								
3	DOOR SILENCER	608								

GROL	GROUP 2									
OFFIC	OFFICE/CONSULT									
3	HINGES	T4A3386	4.5 x 4.5							
1	LOCKSET	AU5404LN			OFFICE FUNCTION					
1	CLOSER	PR3501/3501 BF								
1	KICKPLATE	KP50	8 x 2 LDW	B4E						
1	STOP	403								
3	DOOR SILENCER	608								


GROL	GROUP 3								
SINGL	SINGLE TOILET ROOM/DRESSING ROOM								
3	3 HINGES T4A3386 4.5 x 4.5								
1	LOCKSET	AU5402LN			PRIVACY FUNCTION				
1	STOP	409							
3	DOOR SILENCER	608							


NOTES:

1. REQUIRES CORRIDOR SIDE SPECIAL KEY ACCESS.


DOOR TYPES

STANDARD: STAIN GRADE: CLEAR (NATURAL) STAIN ON ROTARY BIRCH WOOD DOORS

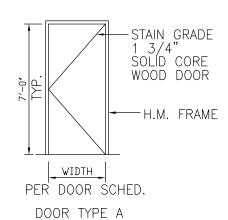


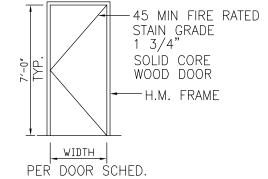

DOOR TYPE B

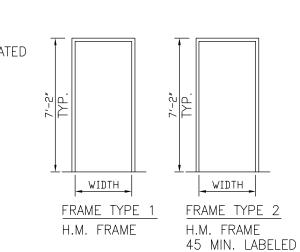

FRAME TYPE

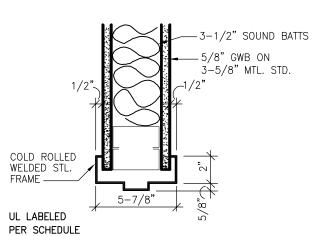


NOTE: WHERE PLANS REQUIRE DOOR FRAMES TO BE REUSED,
THE CONTRACTOR IS TO FIELD VERIFY THAT THE WIDTH
OF THE JAMB IS SUITABLE FOR NEW WALLS.

(1) JAMB (HEAD SIM.)

GROUP 4								
SING	SINGLE ENTRY DOOR TO EXAM							
3 HINGES T4A3386 4.5 x 4.5								
1	LOCKSET	AU5404LN			EXAM ROOM/OFFICE			
1	STOP	WS03						
3	DOOR SILENCER	608						

GROUP 5								
CLOS	ET/STORAGE							
3	HINGES	T4A3386	4.5 × 4.5					
1	LOCKSET	AU5405LN			STORE ROOM FUNCTION			
1	KICKPLATE	KP50	12×2 LDW	B4E				
1	MOP PLATE	KP50	4×1 LDW	B4E				
1	STOP	WS03						
3	DOOR SILENCER	608						

GROUP 6							
BREAK ROOM							
3	HINGES	T4A3386	4.5 x 4.5				
1	SET	AU5401LN			PASSAGE FUNCTION		
1	KICKPLATE	KP50	12×2 LDW	B4E			
1	MOP PLATE	KP50	4×1 LDW	B4E			
1	STOP	WS03					
3	DOOR SILENCER	608					

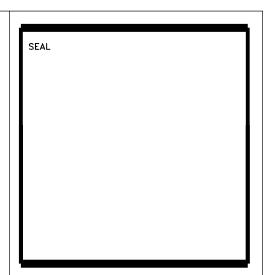

DATE	REVISION		

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BAPTIST MEDICAL CENTER INTERSTATE 95 EXIT 335 14550 OLD ST. AUGUSTINE ROAD JACKSONVILLE, FLORIDA 32258

CREATE TIMESHARE
OFFICE WITH FURNITURE
MOB2 SUITE #2371

SHEET NAME:
DOOR SCHEDULE,
HARDWARE GROUPS.
DOOR TYPES,
FRAME TYPES

SCALE:	AS	NOTED		

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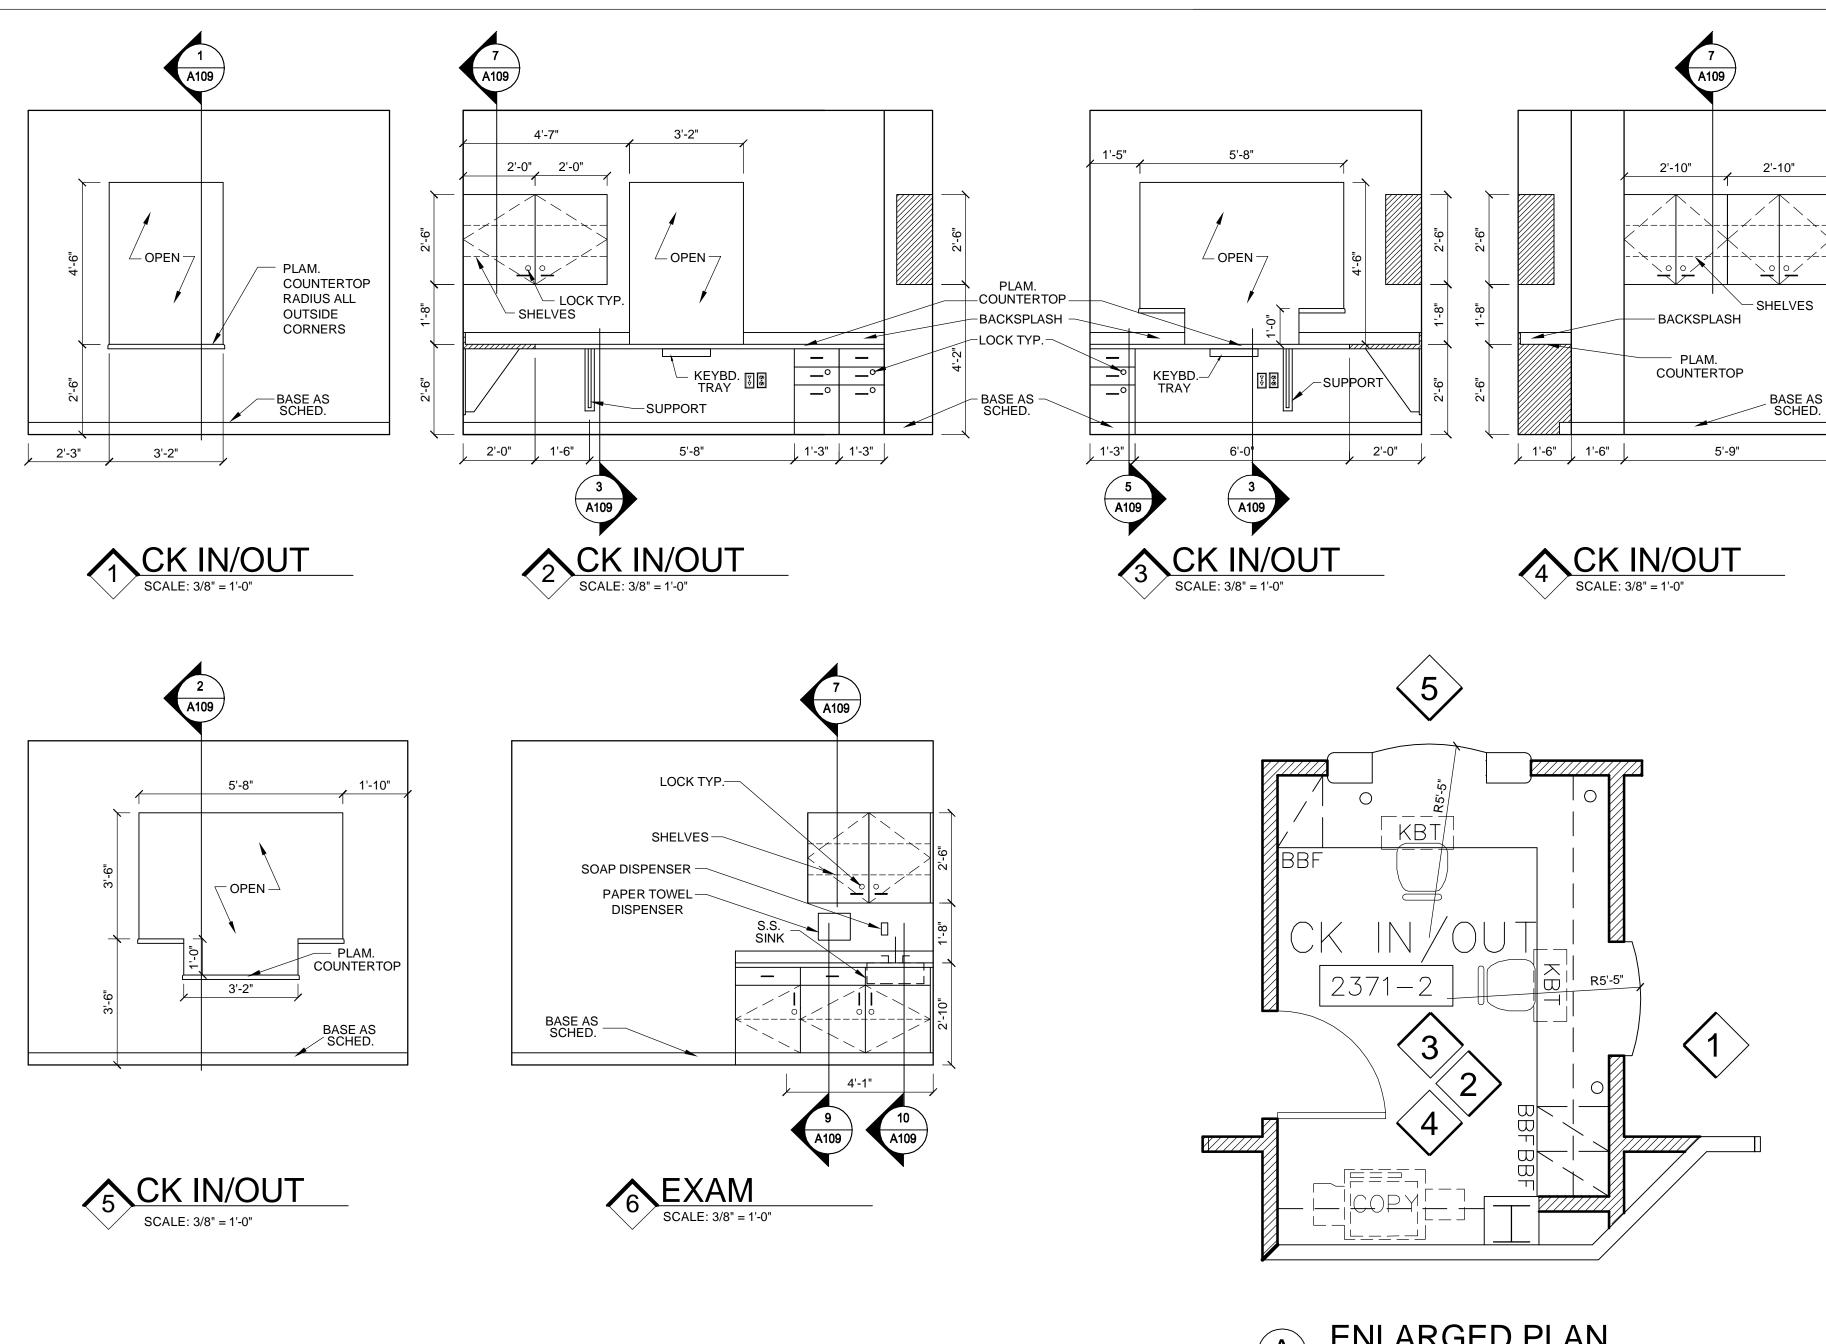
Est. Project GSF: 1,894

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C & A FN: 3943

BOMA SF: 1,792


A106




GENERAL NOTES:

- 1. FIELD VERIFY ALL DIMENSIONS PRIOR TO CONSTRUCTION.
- 2. SUBMIT SHOP DRAWINGS TO OWNER/PROJECT MANAGER/INTERIOR DESIGNER.
- 3. RADIUS ALL OUTSIDE CORNERS ON COUNTERTOPS.
- 4. PROVIDE ALL FRT WOOD BLOCKING NECESSARY FOR INSTALLATION OF MILLWORK UNITS.
- 5. PROVIDE PLAM ON ALL EXPOSED SURFACES.
- 6. PROVIDE GROMMET HOLES AS SHOWN ON PLANS AND IN MILLWORK SECTIONS.
- 7. FINISH ALL END PANELS.
- 8. PROVIDE LOCK ON ALL CABINET DOORS AND DRAWERS UNLESS NOTED OTHERWISE.



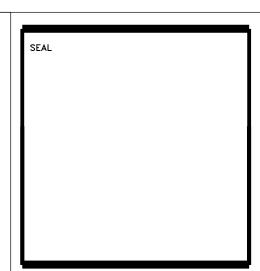

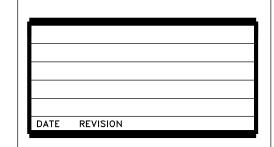

ISSUE DATE: NOVEMBER 09, 2011 ISSUE: PERMIT

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CREATE TIMESHARE
OFFICE WITH FURNITURE
MOB2 SUITE #2371

SHEET NAME:

INTERIOR ELEVATIONS

SCALE: AS NOTED

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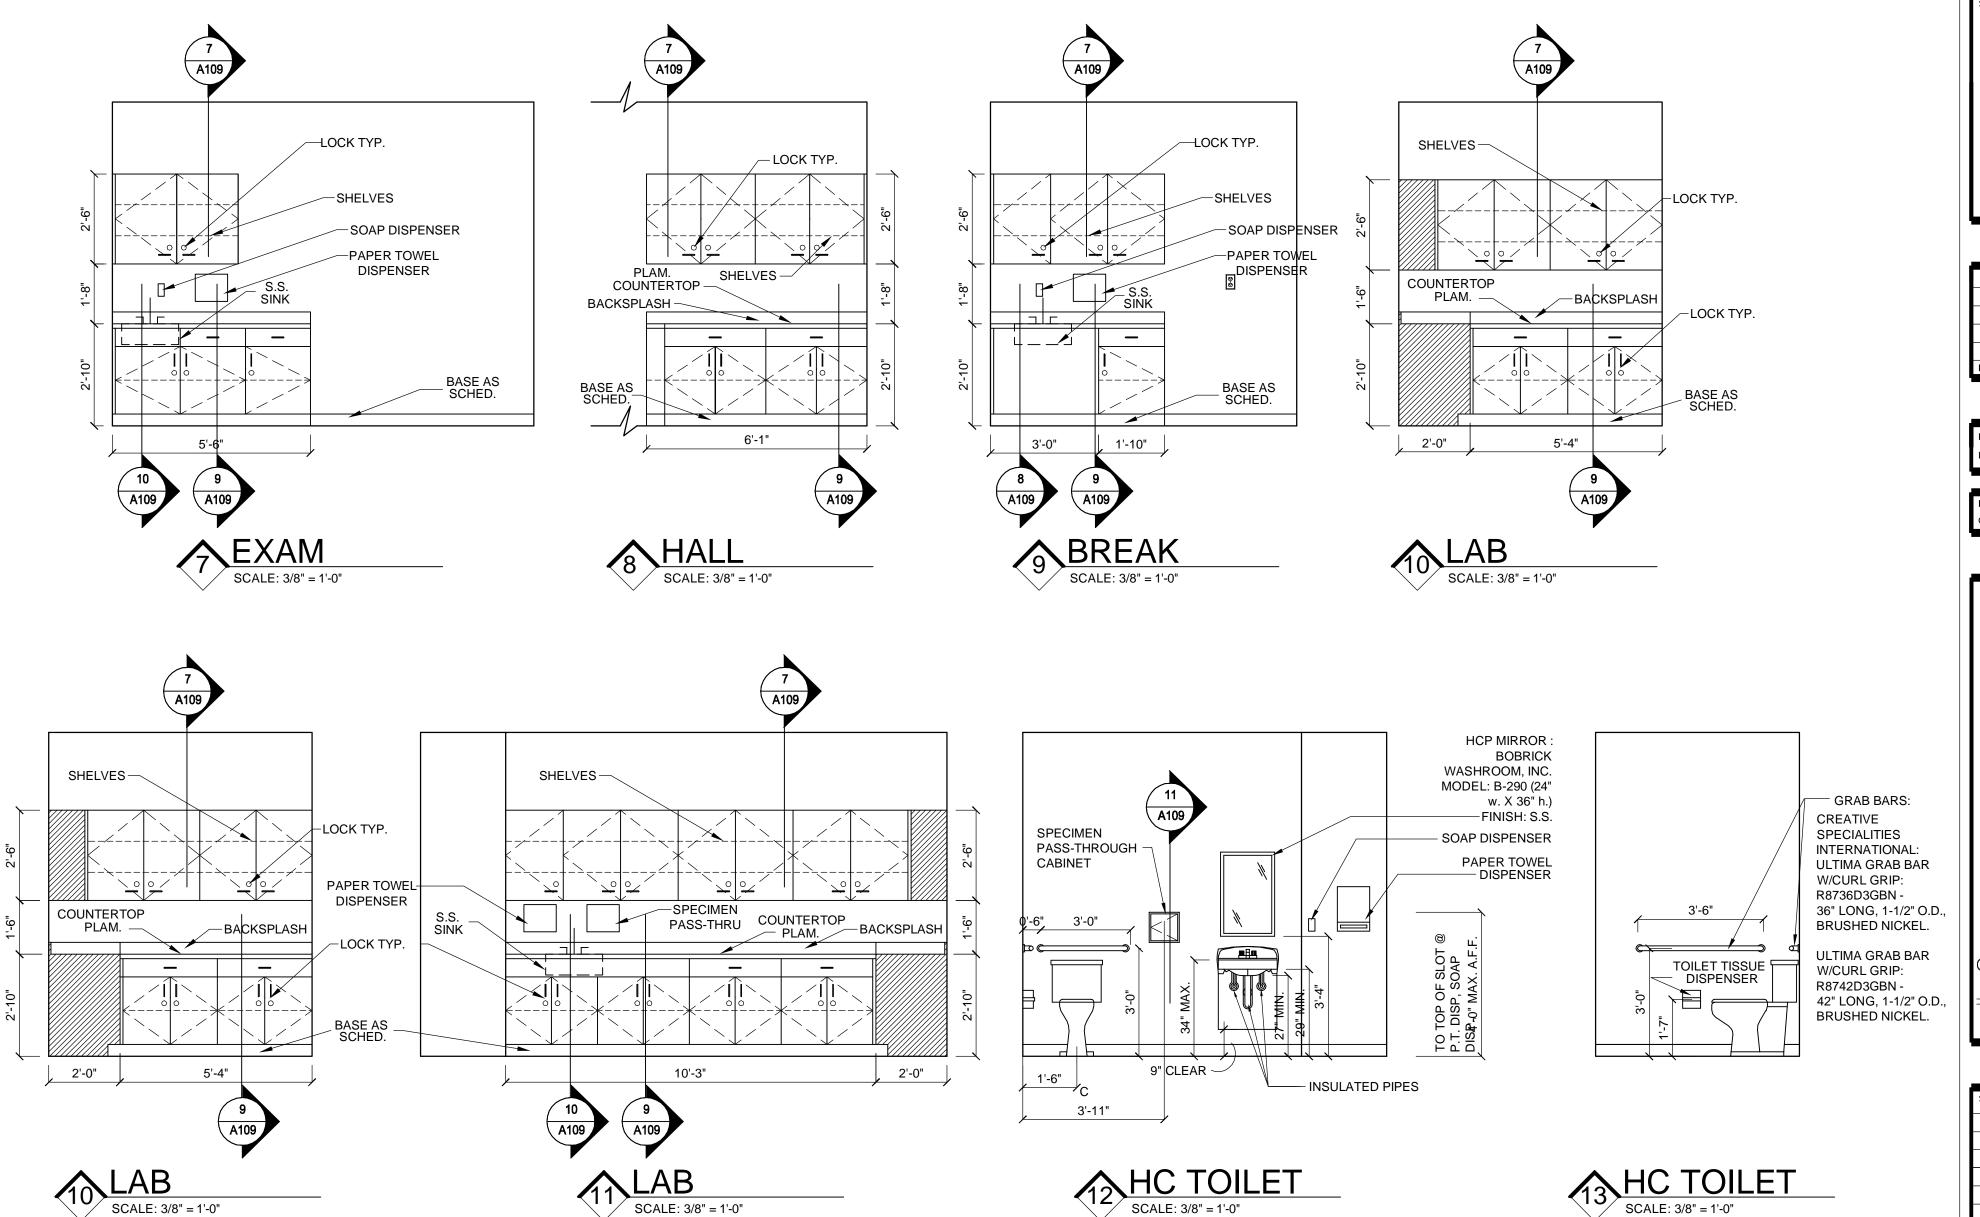
C & A FN: 3943

Est. Project GSF: 1,894

BOMA SF: 1,792

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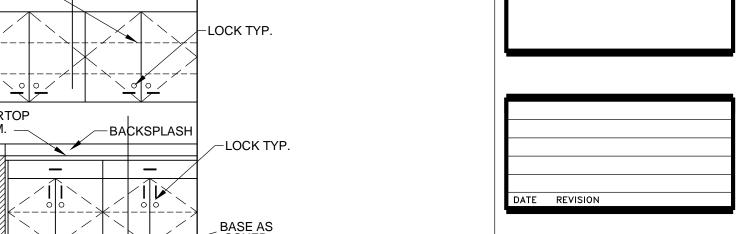


GENERAL NOTES:

- 1. FIELD VERIFY ALL DIMENSIONS PRIOR TO CONSTRUCTION.
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- 3. RADIUS ALL OUTSIDE CORNERS ON COUNTERTOPS.
- 4. PROVIDE ALL FRT WOOD BLOCKING NECESSARY FOR INSTALLATION OF MILLWORK UNITS.

SCALE: 3/8" = 1'-0"

- 5. PROVIDE PLAM ON ALL EXPOSED SURFACES.
- 6. PROVIDE GROMMET HOLES AS SHOWN ON PLANS AND IN MILLWORK SECTIONS.
- 7. FINISH ALL END PANELS.
- 8. PROVIDE LOCK ON ALL CABINET DOORS AND DRAWERS UNLESS NOTED OTHERWISE.



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CREATE TIMESHARE OFFICE WITH FURNITURE MOB2 SUITE #2371

SHEET NAME: INTERIOR ELEVATIONS

SCALE: AS NOTED

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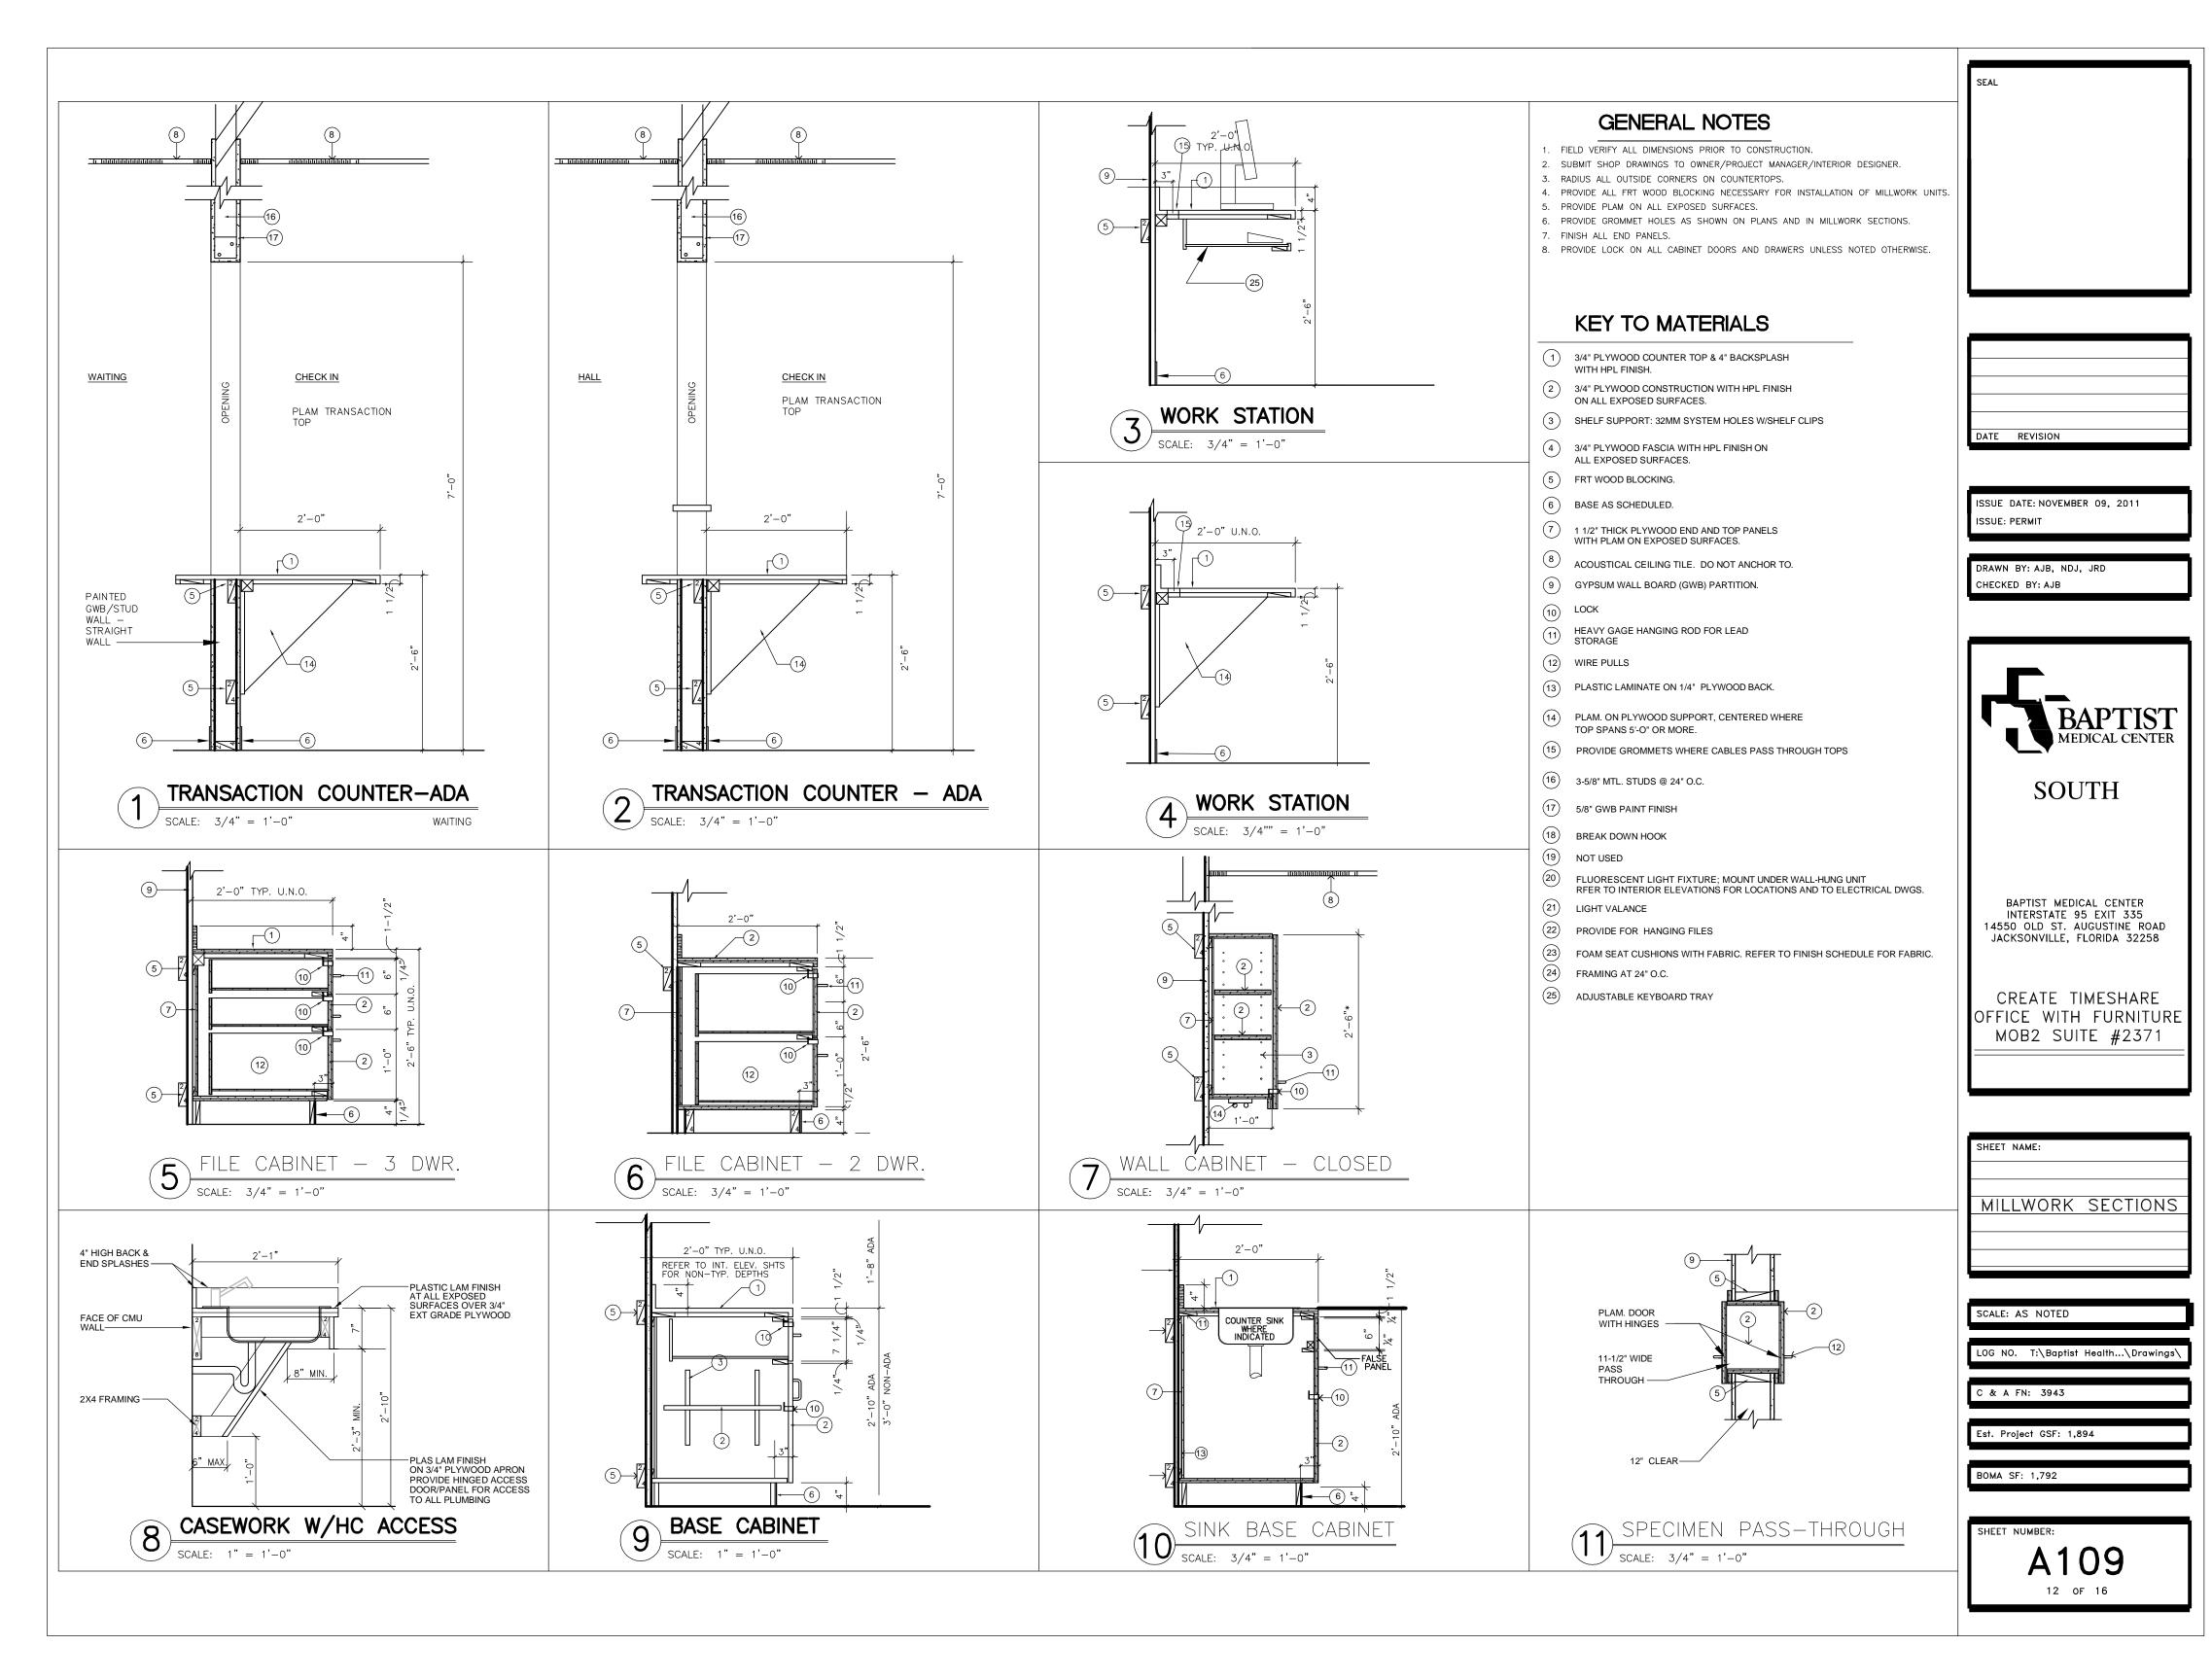
C & A FN: 3943


Est. Project GSF: 1,894

BOMA SF: 1,792


SHEET NUMBER: A108

11 OF 16



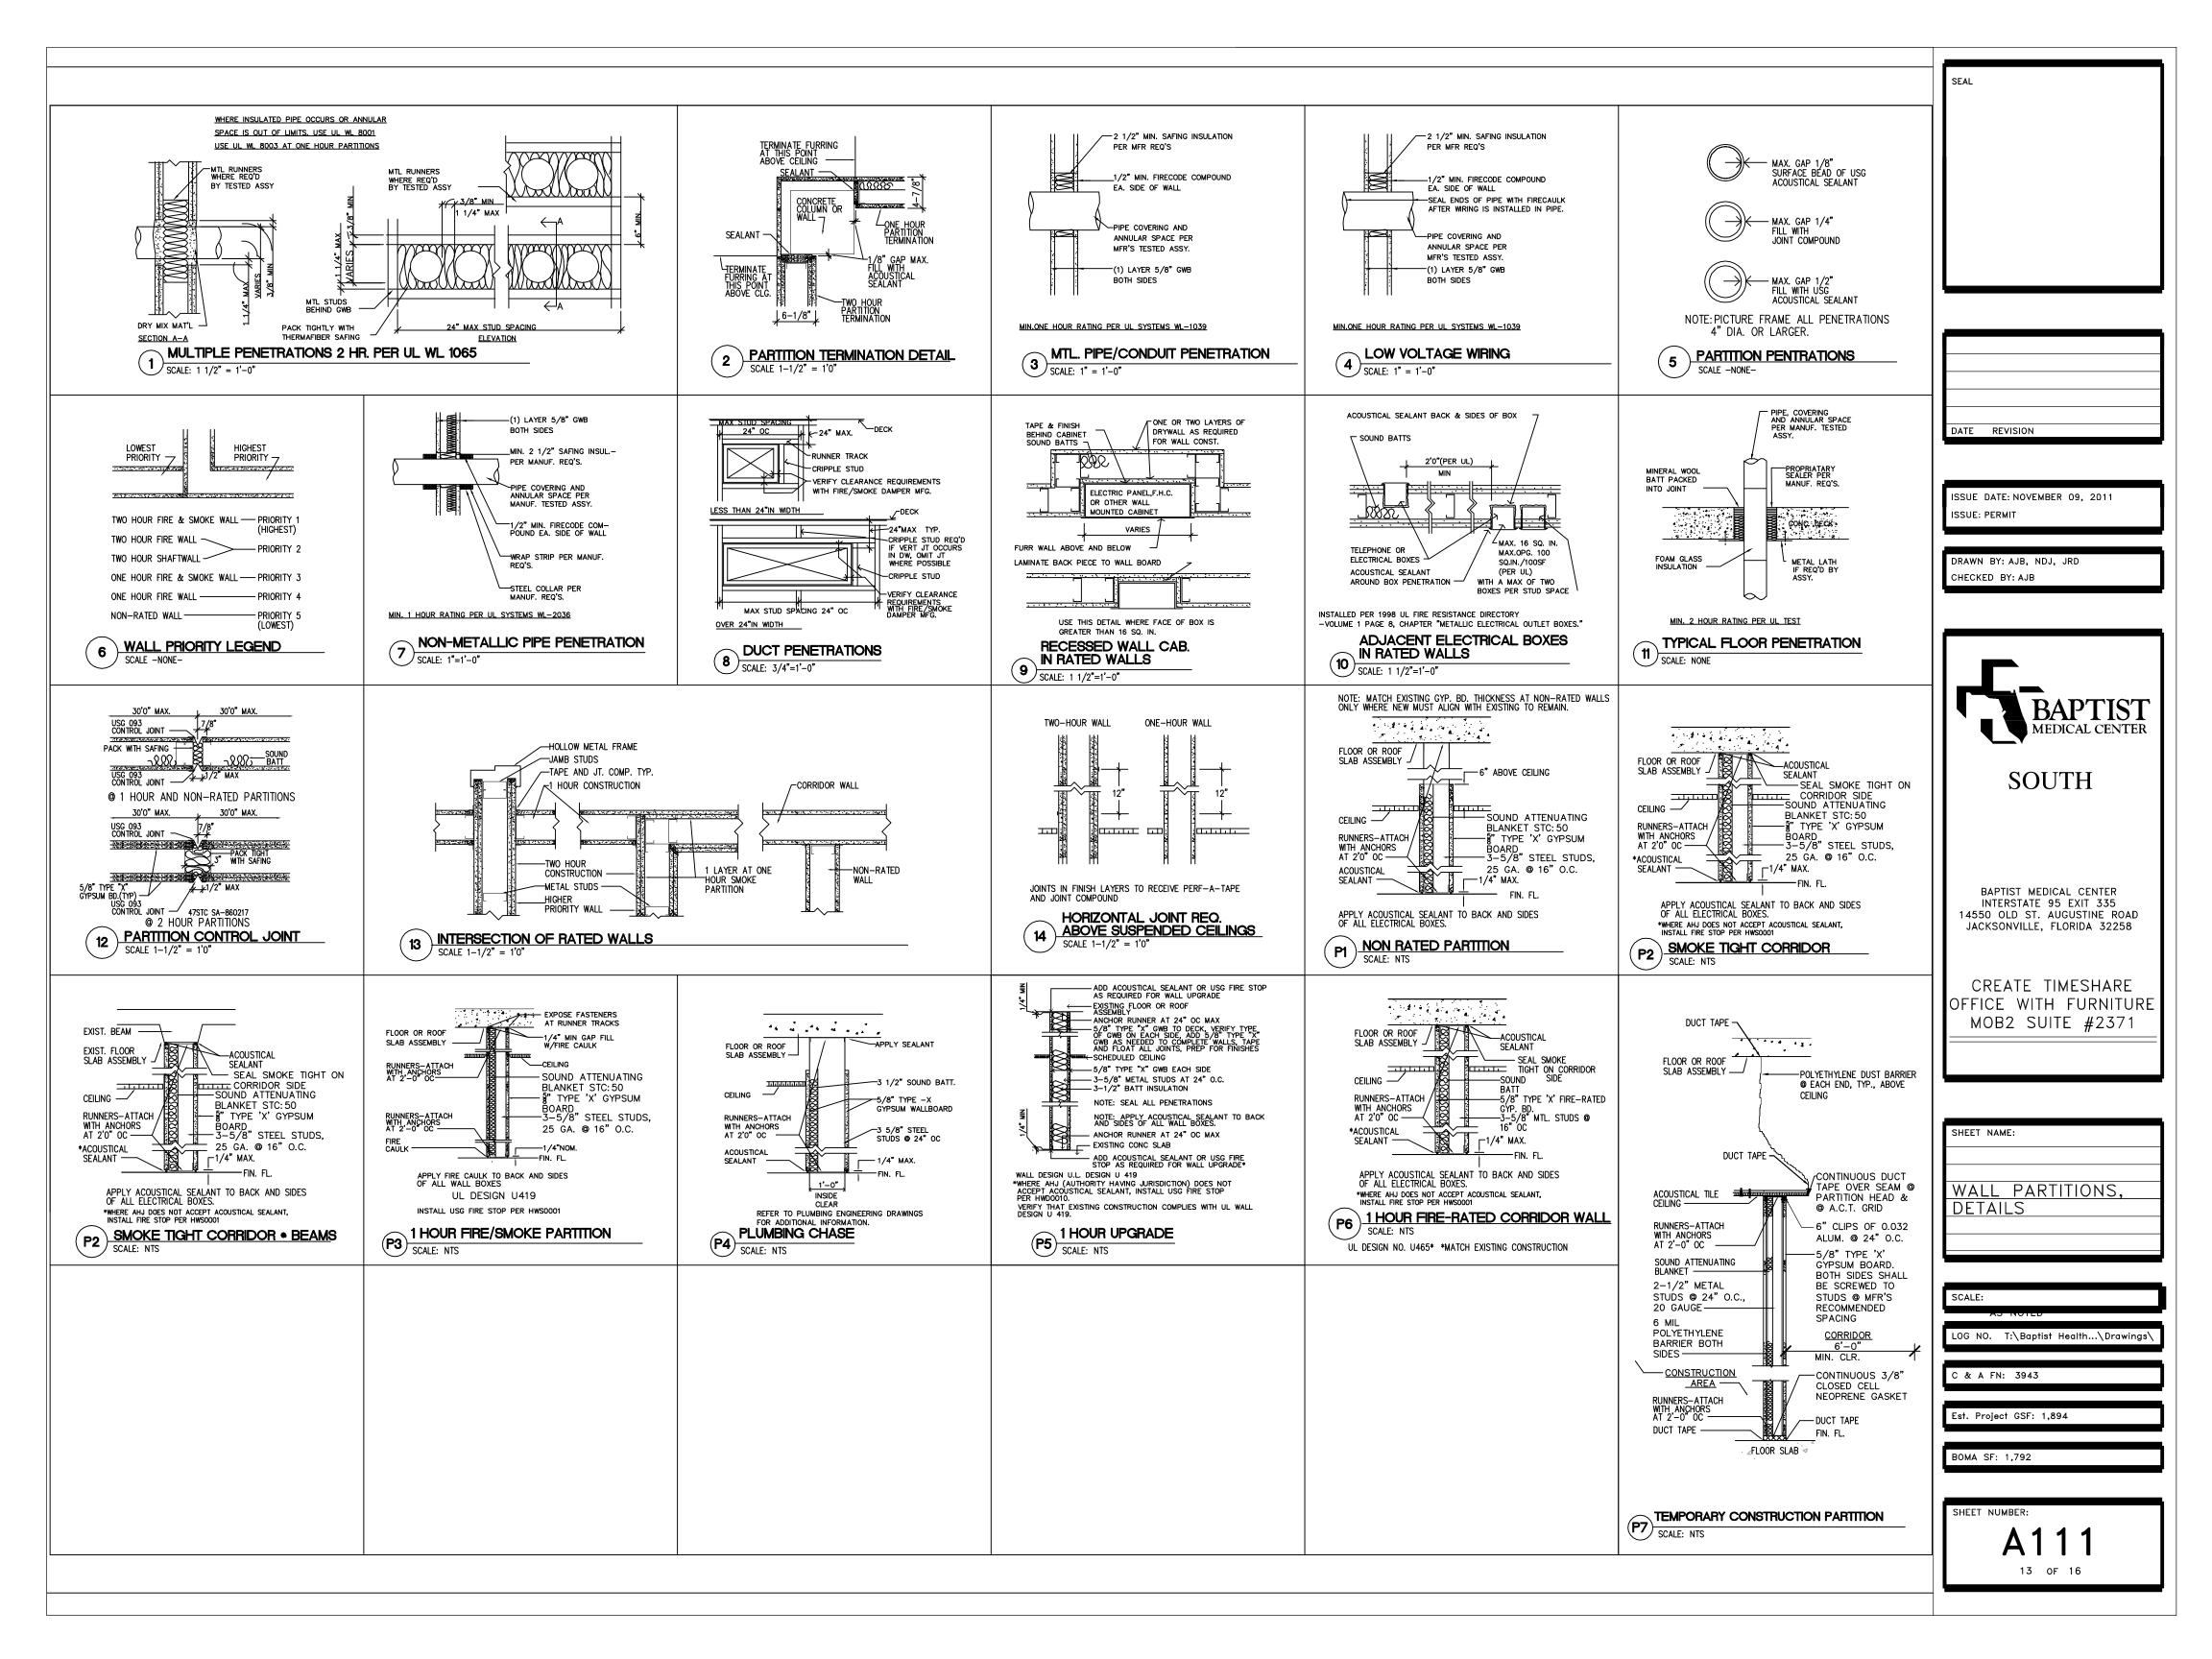


ACCESSORY SCHEDULE EQUIP. LOCATION **DIMENSIONS** MANUFACTURER MODEL NO. FINISH **EQUIPMENT** NO. TAG Bobrick Washroom Equipment, Handicapped S.S. 1 B-290 24" w. X 36" h. 1 **HCP Mirror** Accessible Unisex Toilet **Creative Specialities** Ultima Grab Bar w/Curl Grip 36" long **Brushed Nickel** 2 Grab Bar International R8736D3GBN-36" Creative Specialities Ultima Grab Bar w/Curl Grip 42" long **Brushed Nickel** Grab Bar International R8742D3GBN-42" Bobrick Washroom Equipment, Smooth, No. 4, B-6806 X 36 36" long, O.D. - 1-1/2" 2 Grab Bar - alternate Satin Finish Bobrick Washroom Equipment, Smooth, No. 4, B-6806 X 42 42" long, O.D. - 1-1/2" Grab Bar - alternate Satin Finish Soap Dispenser Tenant Furnished/Tenant Installed Tenant Furnished/Tenant Installed (5) Paper Towel Dispenser Toilet Paper Dispenser Owner Furnished/Owner Installed

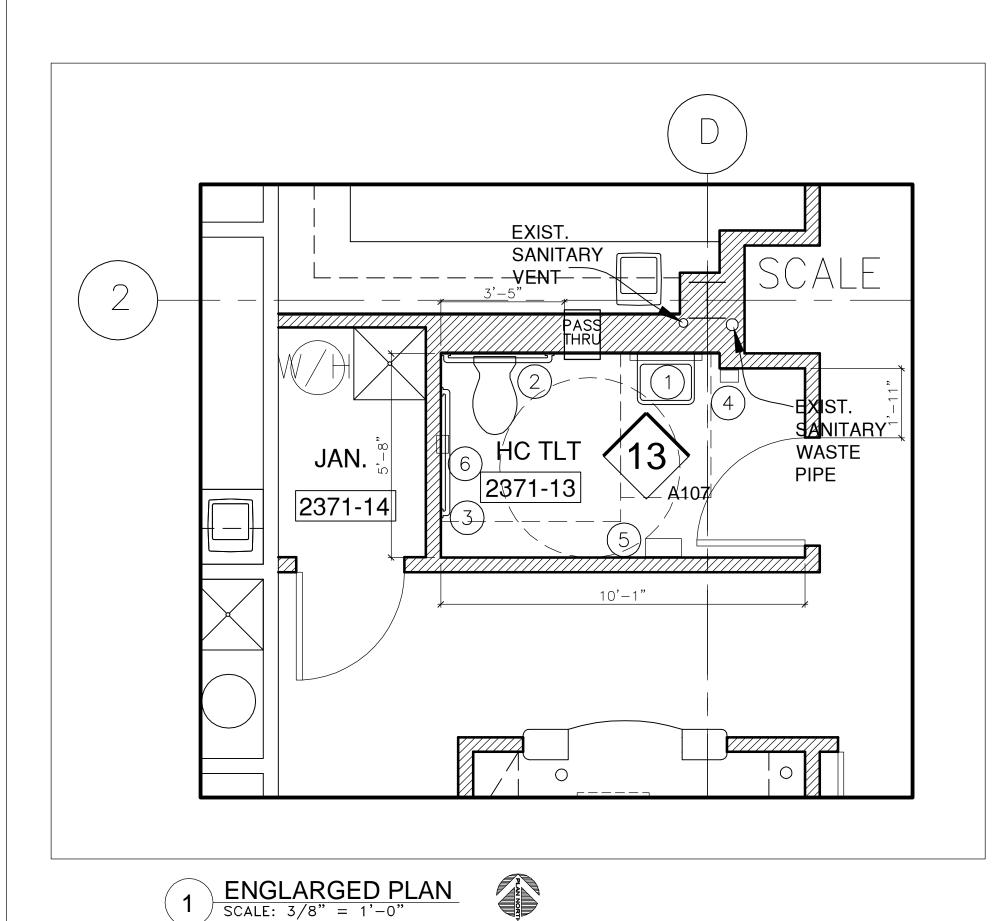


TYPICAL MOUNTING HEIGHTS


ADA ACCESSIBILITY

FIXTURES AND ACCESSORIES INDICATED IN TYPICAL SITUATIONS, SOME COMPONENTS MAY OR MAY NOT BE USED IN EVERY PROJECT. REFER TO ACTUAL FLOORPLAN AND NOTES.

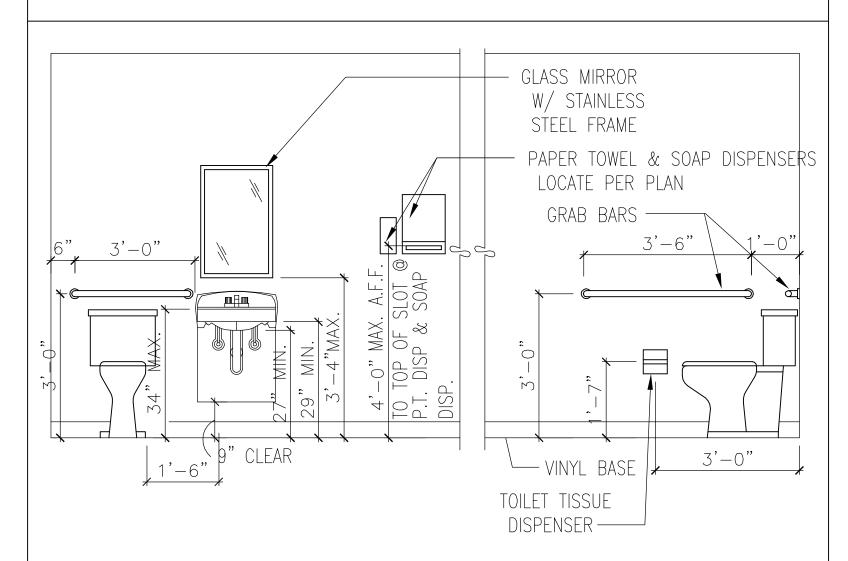

- 1) FLOOR MOUNTED TOILET TO BE 17"-19" A.F.F. PER FACBC 11-4.16.3.
- 2) CONTROLS FOR FLUSH VALVES SHALL BE MOUNTED ON THE WIDE SIDE OF THE TOILET AREA PER FACBC 11-4.16.5.
- 3) GRAB BARS TO COMPLY WITH 11-4.2.6 AND FIG. 29 OF FACBC.
- 4) TOILET ROOM DOOR OPENING WIDTH TO BE 36 INCHES (32" MIN. CLEAR OPENING).
- 5) PIPES AND VALVES UNDER SINK TO BE INSULATED WITH 1/2" ARMSTRONG "ARMAFLEX" INSULATION PER FACBC 11-4.19.4

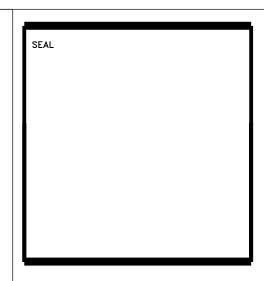

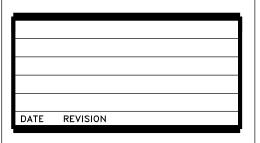

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BAPTIST MEDICAL CENTER
INTERSTATE 95 EXIT 335
14550 OLD ST. AUGUSTINE ROAD
JACKSONVILLE, FLORIDA 32258

DR. BROWN MOB2 SUITE #2497

ACCESSIBLE
DETAILS

SCALE:

LOG NO. T:\Baptist Health...\Drawings\

C & A FN: 3979

Est. Project GSF: 3,263

BOMA SF: 3,106

SHEET NUMBER: **A 1 1 1**14 OF 17

DIVISION 1

GENERAL REQUIREMENTS

DEMOLITION

PART 1 - GENERAL

1.1 DESCRIPTION

A. Include all labor, materials and equipment necessary to complete work as

B. Where walls are shown to be demolished, remove entire wall from floor to underside of deck above.

1.2 INSPECTION

- A. Make adequate examination of existing building to determine scope of alteration work. Become familiar with contract documents and full extent of work required
- B. It is the responsibility of the Contractor/Subcontractor to resolve with the Architect/Engineer all questions, conflicts, and concerns.

1.3 EXECUTION

- A. Each Contractor/Subcontractor shall be responsible for all cutting and patching B. Patch disturbed existing construction to match adjacent undisturbed construction as to materials and finishes unless otherwise indicated on the Finish Schedule.
- C. Patch existing subfloors under removed partitions, fixed equipment, etc. by cutting back, applying underlayment, concrete fill or other acceptable leveling fill as necessary to provide subfloor that is level with adjacent existing subfloors and properly prepare to receive finish flooring.
- D. Openings created in existing construction as a result of removal of materials shall be patched to match adjacent construction as to material finishes, unless
- otherwise indicated. E. In rooms where patching is required in existing acoustic tile/panel ceilings, patch ceilings with matching type and pattern of acoustic tile.
- F. In renovated rooms/areas to receive new wall finishes, those portions of exiting walls that remain shall have their surfaces patched, cut back, brought forward as necessary, and prepared as required to receive the new finishes per room Finish
- G. In renovated rooms/areas to receive new floor finishes, remove existing finish flooring and related materials and prepare subfloor by cutting back, applying concrete fill or other acceptable leveling fill as necessary to provide subfloo that is level and properly prepared to receive new floor finish as required by Room Finish Schedule and material manufacturers written recommendations.

CLEANING

PART 1 - GENERAL 1.1 DESCRIPTION

A. Clean all areas affected by construction.

required for installation of his work

PART 2- PRODUCTS

2.1 CLEANING MATERIALS

- A. Use only cleaning materials recommended by manufacturer of surface to be cleaned.
- B. Use cleaning materials only on surfaces recommended by cleaning material manufacturer

PART 3 - EXECUTION 3.1 DURING CONSTRUCTION

- A. Provide sufficient quantity of waste containers on floor of construction for collection of waste materials, rubbish, and debris.
- B. Collect area waste containers and deposit waste in main dumpster-type containers on a daily basis
- 3.2 FINAL CLEANING
- A. Period of cleaning: At completion of construction just prior to acceptance or occupancy.
- B. Extent of cleaning: Thoroughly broom clean and wash resilient tile floors.
- Thoroughly broom clean and wash resilient tile floors.
- 2. Remove grease, dust, dirt, stains, labels, fingerprints, and other foreign materials from interior and exterior surfaces, including but not limited to glass, finish hardware, painted surfaces, flooring, fixtures, equipment. 3.3 INFECTION CONTROL MEASURES
- A. Contact the Project Manager for Information regarding Infection Control Measures.

RECORD DOCUMENTS

1.1 SUBMITTAL OF AS-BUILT DOCUMENTS

- A. At completion of the project, the contractor shall transfer one set of reproducible vellum's or mylars, all delineated as "As Built" modifications made to the original Contract Documents during construction period.
- B. Reproducible shall be the same size and scale as original contract documents. Certify to their accuracy and completion. All modifications clearly marked for identification.

SUBMITTALS

- 1.1 SUBMITTAL OF SHOP DRAWINGS, PRODUCT LITERATURE, SAMPLES
- A. Submit shop drawings, product data samples to owner for review & comment. Submit 7 copies of shop drawings and product data. Submit two sets of samples.
- B. Identification
- (1.) Clearly mark each copy to identify pertinent materials, products,
- (2.) Modify information to delete information not applicable to this
- (3.) Show dimensions and clearances required by Code requirements.
- (4.) Show performance characteristics and capacities.
- (5.) Show wiring diagrams and controls.
- C. Contractor to review, comment and stamp submittals prior to submitting to owner. Submittals without contractor's stamp of review will not be reviewed and will be returned for resubmission
- D. Contractor to attach transmittal letter with submittals with date project title and number, contractor's name and address and notification of deviations from contract documents

DIVISION 5

MISCELLANEOUS METALS

1.1 DESCRIPTION

- A. Include all labor, materials and equipment necessary to complete work as drawn and specified
- B. Provide and install ASTM 36 steel lintels at new door and mechanical openings

DIVISION 6

CARPENTRY & MILLWORK

1.1 DESCRIPTION A. Include all labor, materials and equipment necessary to complete work as drawn and specified.

1.2 SUBMITTALS

PART 1 - GENERAL

A. Submit shop drawings indicating size & location of each piece of millwork, elevations, details of construction and other pertinent data to owner.

PART 2 - PRODUCTS

- 2.1 MATERIALS A. All lumber built into partitions shall be fire retardant treated
- B. All millwork shall comply with AWI custom Grade construction standards. Flush overlay construction. Plywood core - no exceptions
- C. Cabinets: Exterior Vertical Grade Laminate. Interior white liner panels. Face plates and screw strips solid pine. Tops, bottoms, and sides: 3/4" birch plywood. Backs: 1/4" birch plywood. Adjustable shelves: 3/4" birch plywood with veneer edge.
- D. Doors and Drawer Fronts: 3/4" plywood with vertical grade laminate on both
- E. Drawer Boxes: Sides 1/2" birch plywood, bottoms 1/4" birch plywood with white
- File drawers to have bars for legal and letter suspended files.
- F. Countertops: Labs, Exam Rooms, X-ray, Areas with sinks or Wet Areas: 3/4" MARINE GRADE plywood core (no exceptions) with 1-1/2" solid pine drop edge, plywood backsplash 4" high unless specified otherwise. Chemsurf plastic laminate at Labs.
- G. Countertops: Business Offices, Desks, Areas with no sinks or in Dry Areas: 1-1/4" nova-ply with backing sheet on bottom, plywood back splash 4" high unless specified otherwise. High Pressure grade laminate.
- H. Hardware:
 - Horizontally applied, back mounted, solid metal, 6 inches long, 10MM in diameter, 32 MM in projection wire pulls. 1. EPCO, AP128-SS
 - 1. Box Drawer Slides: For drawers not more than 6 inches high and 24 inches wide: a. Blum, 230M Series

2. File Drawer Slides

Knap & Vogt 8400 for file drawers 24" wide and under. Knap & Vogt 8500 for file drawers over 24" wide.

Drawer slides: BHMA A156.9, B05091

3. Lap Drawer/Pencil Drawer Slides:

a. Knap & Vogt, 8200 Hinges: Frameless concealed hinges (European type): BHMA A156.9, B01602, 120 degrees of opening, stamped steel nickel plated, self-closing.

1. Blum, clip to top 120* Hinge 71T5580

2. Blum, clip stamped mounting plate 174e6100.01 Shelf supports, cabinets: BHMA A156.9, b04013; metal 5MM shelf pins, 5MM holes continuously bored top to bottom.

- 1. Hafele, nickel-plated zinc, catalogue # 282.24.710 Swinging Door Locks: BHMA A156.11, E07121. Drawer locks: BHMA A156.11,
 - 1. Compx National Lock Number C8053-14A.
 - 2. Provide locks where indicated.
 - 3. Provide a minimum of two keys per lock and six master keys.
 - Key locks as directed by Owner 4. Key code C415A to be exclusively used on all locking sink base cabinets.

Grommets: for cable passage through countertops:

- Provide matte black, moded-plastic grommets & matching plastic caps with slot for
- Product: Through countertops: Subject to compliance with requirements, provide 2 inch "TG3 Series" flip-top grommet set by Doug Mockett & Company, Inc.
- Countertop Supports: 1-1/8" INDUSTRIAL GRADE PLYWOOD with laminate cladding on all exposed surfaces.
- Trash Hole Trim: 6-3/4 inch O.D. by 6" deep. 1. Product: Doug Mockett and Company, INC: TM1A-PSS, polished
- 2. Optional Trash Hole lid if indicated in Design: Doug Mockett and Company, INC: TMLID 1-PSS
- Cabinet Doorthumb Latches: Nickle plated brass
- Exposed Hardware Finish: For exposed Hardware, provide finish that complies with BHMA Satin Stainless Steel: 630, unless otherwise indicated.
- For concealed hardware, provide manufacturer's standard finish that complies with product class requirements in BHMA A156.9.
- I. Walls behind casework to be primed.
- J. Where outside corner of countertop is exposed to impact, provide 3" radius.

DIVISION 8 METAL FRAMES AND DOORS

PART 1 - GENERAL

1.1 DESCRIPTION

- A.Furnish all materials necessary to complete the hollow metal work indicated and as specified herein. See drawings and schedule for type, size, design and location of metal doors, metal frames, matching panels, trim, etc
- 1. Provide metal UL labels on doors and frames where scheduled. Provide 250 degree temperature rise label at all 'B' label doors. 1.2 SUBMITTALS
- A. Submit product data and shop drawings showing gauge and construction.
- PART 2 PRODUCTS

2.1 MATERIALS

A. Doors and frames of Ceco, Steelcraft, Amweld, Mesker or other approved. B. Frames: Cold rolled steel frame sections arranged as shown on the drawings

2. Exterior Frames: 16 Gauge, minimum.

- and of gauges indicated below 1. Interior Frames: 18 Gauge, minimum.
- C. Doors: 1 3/4" thick, seamless sheet steel, flush type hollow metal, arranged as
- 1. Interior doors: 18 gauge sheet steel, minimum. 2. Exterior doors: 16 gauge sheet steel, minimum.

WOOD DOORS PART 1 - GENERAL

1.1 DESCRIPTION

A. Furnish all wood doors indicated and as specified herein.

See drawings and schedule for type, size and location. 1.2 SUBMITTALS

A. Submit shop drawings of product data including manufacturer's specifications for wood doors, and other pertinent data.

PART 2 - PRODUCTS

- 2.1 MATERIALS
- A. Doors shall be Algoma Hardwoods, Eggers, Paine, Weyerhauser or other approved equal.
- B. Face veneer shall be premium grade; rotary cut birch.
- C. Solid Core Doors: Glued block core of low density wood, 2 1/2" maximum width, random lengths with joints well staggered. Matching edge bands not less than 1-3/4" thick. Face panels: 2 or 3 ply having combined thickness of 1/12" with face veneer not less than 1/36" thick. Type I glue.

D. UL Labeled Wood Fire Doors: Mineral board core with matching hardwood edge strips minimum 1-3/4" thick. Include UL label as scheduled. All labeled wood doors shall be pre-fit and shall require no field trimming or machinery. Provide 250 degrees temperature rise label at 'B' label doors. Provide metal

HARDWARE

PART 1 - GENERAL

1.1 DESCRIPTION

UL labels on door.

- A. Furnish all materials necessary to complete the hardware indicated and as specified herein
 - 1. Provide metal UL labels on rated hardware.
 - 2. Provide delay action closers on all doors over 36" in width.
- 3. Provide silencers at all hollow metal frames.
- 1.2 SUBMITTALS
- A. Submit an itemized hardware schedule indicating Architect's opening number, hardware group number, manufacturer's name, catalog number, material, finish, size, thickness, hand, function, style, fastenings, door and frame material, size and label designation, etc. Along with catalog cuts and technical data for
- 2.1 PRODUCTS

HARDWARE GROUPS:

For approved hardware manufacturers, refer to Baptist Health System Plant Facilities Website.

Refer to schedule on Door Schedule Sheet

PART 1 - GENERAL

- 1.1 DESCRIPTION
- A. Furnish all material, labor, equipment and services necessary to complete the installation of the glass work.

GLASS AND GLAZING

1.2 SUBMITTALS

A. Submit manufacturer's product literature for the glass, and windows.

PART 2 - PRODUCTS

- 2.1 MATERIALS A. Mirror glass: 1/4" thick polished plate or float glass, quality q3, tempered, without tong marks, frameless mount.
 - 1. Clips: Stainless steel for blind clip application. Mastic: Manufacturers recommended mastic for spot application, 1/8" bed
- thickness. Support at lower edge only. B. Hordes Brothers Co., 1/4" thickness, polished Misco welded square pattern.
- 1. Glazing Compound: DAP 33 glazing compound C. Tempered Glass: 1/4" thickness, quality q3 polished plate or float glass.

DIVISION 9

- PART 1 GENERAL
- 1.1 DESCRIPTION A. Furnish all material, labor, equipment and services necessary to complete the
- installation of the drywall work B. All fire rated assemblies shall be constructed in strict accordance with the
- 1.2 SUBMITTALS
- A. Submit product data.
- PART 2 PRODUCTS 2.1 MATERIALS
- A. All materials shall be delivered to the job in original un-opened containers or bundles, and stored so as to prevent damage B. Framing Materials: 1. Metal Studs: 3 5/8" (6" where shown) 25 gauge electro-galvanized,
- roll formed, metal studs with floor and top runner tracks. 20 gauge studs where shown on drawings.
- 2. Furring Channels: 1-1/2" furring channels. Suppliers/Manufacturers:
 - (a.) Cemex supplies: Dietrich Industries {www.dietrichindustries.com} and Steel Consystems (www.steelconsystems.com) (b.) Clark: Phone 800-543-7140
- (c.) CEMCO (West): Phone 800-775-2362 C. Gypsum Drywall Board Materials: 1. Exposed Drywall: USG SHEET ROCK, tapered edge or SW tapered edge,
 - 5/8" thick; gypsum wallboard meeting ASTM C-36. a. Provide Type "X" gypsum wallboard to meet requirements. b. Where drywall is the substrate for ceramic tile, provide sheetrock W/R moisture resistant wallboard meeting ASTM C-630.
- 2. Exposed Drywall: USG SHEET ROCK, tapered edge or SW tapered edge, 5/8" thick; gypsum wallboard meeting ASTM C-36. D. Acoustical Sealing.
 - At sound insulated partitions, apply caulking bead on both sides of floor runner, walls at dissimilar materials. Set wall board into caulking bead. At partition intersections, seal face layer with caulking bead prior to application of joint treatment. Seal perimeter, back and sides of all electrical boxes.

PAINTING

PART 1 - GENERAL

- 1.1 DESCRIPTION A. Furnish all material, labor, scaffolding and equipment required to complete all
- work shown on the drawings and specified herein B. Paint all exposed surfaces except where the natural finish of the material is obviously intended and specifically noted as a surface not to be painted. Where items or surfaces are not specifically mentioned, paint these the same
- as adjacent similar materials or areas. Also include: 1. Painting of exposed piping, conduit, ductwork, insulated piping, equipment, stands, hangers and other mechanical or electrical work. See Mechanical, Plumbing, Fire Protection & Electrical Drawings for color requirements.
- 2. Painting of all existing metal doors and door frames, where shown 3. Painting of existing metal, wood, etc., on exterior to match new work, where
- C. Do not paint any moving parts of operating units, mechanical and electrical parts, such as valve and damper operators, linkages, sensing devices, motor
- and fan shafts, unless otherwise indicated D. Do not paint any code required labels, such as Underwriter's Laboratories and Factory Mutual, or any equipment.
- E. Include priming of all walls behind casework.
- 1.2 SUBMITTAL
- A. Submit product data with material list and manufacturer's information.

PART 2 - PRODUCTS

2.1 MATERIALS

A. Paints and Varnishes: ICI, SHERWIN WILLIAMS series, type and quality scheduled.

2.2 PAINT SCHEDULE

A. Interior Ferrous Metals: First Coat Latex enamel undercoat Second Coat Latex semigloss Third Coat Latex semigloss

B. Drywall, Plaster:

2 coats stain varnish.

First Coat Latex enamel undercoat Second Coat Latex eggshell Latex eggshell Third Coat

C. Doors: 1 coat paste wood filler. 1 coat alkyd penetrating stain.

PART 1 - GENERAL

1.1 DESCRIPTION A. Furnish all material, labor, equipment and services necessary to install the resilient flooring, as indicated in the Room Finish Schedule and on the drawings. Material shall be installed by contractors approved by the manufacturer and in strict accordance with manufacturer's application

RESILIENT FLOORING

instructions 1.2 SUBMITTALS

- A. Submit shop drawings of product data including manufacturer's specifications. 2.2 MATERIALS A. Resilient Flooring
- 1. Sheet Vinyl Composition Tile: Straight grained pattern, 1/8" x 12" x 12" size. Flooring shall have radiant flux Class 1 flame spread of 0.45 w/sq. cm. or greater when tested per ASTM E648, and smoke density of 450 or less when tested per ASTM E662. 2. Sheet Vinyl Flooring: as specified on Finish Schedules.
- The vinyl shall be manufactured in accordance with ASTM Specification F 1303-94, Type II, Grade 1, Class A. Provide transition strips as necessary for adjoining dissimilar materials. 3. Base: 1/8" thick, 4" high top set rubber cove with job formed internal and external corners. The base shall conform fully to the requirements of the U.S. Federal Specification No. SS-W-40a, Type 1, Rubber.

Per ASTM E84-769, the base shall have a flame spread value (GWL CARPETING

PART 1 - GENERAL

method) of 145.

- 1.1 DESCRIPTION A. Furnish all labor, material, equipment and services necessary to produce a complete carpet installation for all areas indicated in the Room Finish
- 1. Include all necessary binding, sewing, attachment strips, edge strips, seam cement adhesives, etc. 1.2 QUALITY ASSURANCE

A. Carpet installer shall be a firm which has at least five years successful

- experience in carpet installation similar in size and type to the carpeting requirements of this project. 1.3 SUBMITTALS
- A. Submit shop drawings of product data including manufacturer's specifications for carpeting, and samples. B. Carpet shall have certified radiant flux(Class I) flame spread rating (ASTM E-648) of 25 or less and smoke developed of 450 or less when tested in accordance with ASTM E84.

PART 2 - PRODUCTS

A. Carpet material: refer to Finish Schedule.

2.1 MATERIALS

- ACOUSTICAL TREATMENT PART 1 - GENERAL 1.1 DESCRIPTION
- A. Furnish all material, labor, equipment and services necessary to install acoustical treatment indicated in the Room Finish Schedule 1.2 SUBMITTAL A. Submit product data with 12" x 12" samples of acoustical tile, samples of grids, and
- product test reports. PART 2 - PRODUCTS
- 2.1 MATERIALS A. Acoustical Tile (ACT-1): Armstrong, refer to finish schedule, 3/4" x 24" x 24". Class A flame spread rating, of 25 or less per ASTM E84.
- C. Acoustical Tile (ACT-2): Provide mylar-faced acoustical ceiling tile. Class A flame spread rating. D. Ceiling Grid (Grid-2): Refer to Finish Schedule

Smoke Developed of 450 or less per ASTM E84.

B. Ceiling Grid (Grid-1): Armstrong, refer to finish schedule.

NOTE:

Refer to the new BHS Standards for Construction and Finishes. All contractors and subcontractors shall familiarize themselves with the new BHS Standards.

ISSUE DATE: NOVEMBER 09, 2011 ISSUE: PERMIT

DRAWN BY: AJB, NDJ, JRD CHECKED BY: AJB

DATE REVISION



BAPTIST MEDICAL CENTER INTERSTATE 95 EXIT 335 14550 OLD ST. AUGUSTINE ROAD

JACKSONVILLE, FLORIDA 32258

CREATE TIMESHARE OFFICE WITH FURNITURE MOB2 SUITE #2371

SHEET NAME: **SPECIFICATIONS**

LOG NO. T:\Baptist Health...\Drawings\

C & A FN: 3943

BOMA SF: 1,792

Est. Project GSF: 1,894

SHEET NUMBER:

DIVISION 9

CERAMIC TILE AND MARBLE WORK

PART 1 - GENERAL

1.1 DESCRIPTION

- A. Include all labor, materials and equipment necessary to complete the ceramic tile and marble work shown on the drawings and specified herein. Briefly, this includes:
- 1. Organic adhesive application of ceramic tile walls on drywall substrate.
- 2. Dryset application of ceramic tile on floor.

1.2 QUALITY ASSURANCE

A. Tile shall conform to TCA 137.1, Standard Grade.

1.3 SUBMITTALS

A. Submit manufacturers current sample chart for tile color groups specified for the purpose of color selection and product data.

PART 2 - PRODUCTS

2.1 MATERIALS

- A. Ceramic Wall Tile: Standard Grade, domestic, matte glazed 4 1/2" x 4 1/2"m cushion edge, sheet mounted.
- B. Ceramic Floor Tile: Standard grade, domestic, porcelain type, unglazed ceramic mosaics, approximately 1/4" thick. 2" X 2" face size, quick set mounted.
- C. Ceramic Tile Integral Base: Standard grade, domestic, porcelain type, unglazed ceramic tile cove base, approximately 1/4" thick, equal to Dal-Tile Cove C-833, Corner Cove SU-813. Interior Corner Cove CB-813.
- D. Wall Tile Adhesive: Upco "Tile-Mate" 5100 or other approved solvent adhesive exceeding CS-181-52 and bearing TCA hallmark.
- E. Dry Set Mortar: Tile-Mate 763 or 964 gray premixed self curing thin set mortar.
- F. Grout:
- 1. For Ceramic Tile Walls: Tile-Mate "Flexible", latex modified portland cement grout, in color as selected by the Architect.
- 2. For Ceramic and Quarry Tile Floors: "Hydroment" joint filler, in color as selected by the Architect.

PART 3 - INSTALLATION

3.1 INSTALLATION

- A. Layout tile on walls, so that no tile less than half size occurs. Align joints in wall tile vertically and horizontally; no staggered joints permitted. Adjust tile before initial set takes place to provide uniform joint widths.
- B. Install tile prior to acoustical ceiling work.
- C. Contractor to prepare floor surfaces to accept tile in accordance with ANSI A108 standards.

3.2 PREPARATION OF DRYWALL SURFACES

A. Prime gypsum wallboard if recommended by the adhesive manufacturer.

3.3 CERAMIC WALL TILE APPLICATION

- A. Spread adhesive on wall surfaces with notched trowel of type recommended by the adhesive manufacturer. Cover surface uniformly, with no bare spots. Apply adhesive only in areas which are to be tiled before adhesive films over.
- B. Maintain uniform width, plumb and level, joint widths. If tile are self-spacing, provide string spacers removed prior to grouting, but not until adhesive has set.

3.4 DRY-SET APPLICATION

- A. Clean slab or mortar base. Dampen if dry, but do not saturate. Float mortar over area no greater than can be covered with tile while mortar remains plastic. Comb mortar with notched trowel within 10 minutes before applying tile.
- B. Press and beat tile into freshly notched mortar to obtain 100% contact with mortar bed. Use strings or pegs to obtain uniform sheet spacing.
- C.Trowel a layer of mortar on back or rib backed tile to obtain full contact coverage. Use spacers or wet rope to obtain full contact coverage and to obtain uniform joint width for quarry tile.

3.5 GROUTING TILE

- A. Follow manufacturers instructions for mixing and curing grout.
- B. Force grout to solidly fill joints with sponge or striking tool. Fill joints in square edge tile flush.

3.6 DIVISION STRIPS

- A. Set metal division strips in saw joint at doorways and other terminations of floor tile. Set flush with finish elevation of tile.
- B. The completed work shall be free of broken, damaged or otherwise faulty tile, level and true.

3.7 CLEANING

- A. Wet and remove paper and glue from face mounted tile sheets before initial set takes place. Avoid use of excess water. Adjust any tile out of line at this time.
- B. Sponge and wash tile thoroughly, diagonally across joints. Finally, polish with clean dry cloths.

3.8 CURING

A. Damp cure cement set tile work for at least 3 days and keep traffic off floors during this period.

SEAL

DATE	REVISION		
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ISSUE DATE: NOVEMBER 09, 2011
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BAPTIST MEDICAL CENTER INTERSTATE 95 EXIT 335 14550 OLD ST. AUGUSTINE ROAD JACKSONVILLE. FLORIDA 32258

CREATE TIMESHARE
OFFICE WITH FURNITURE
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SPECIFICATIONS

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Est. Project GSF: 1,894

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PLUMBING ABBREVIATIONS SYMBOL DESCRIPTION SYMBOL DESCRIPTION - ABOVE FINISH FLOOR FD - FLOOR DRAIN - DOMESTIC HOT WATER - DOMESTIC COLD WATER - DOMESTIC HOT WATER RECIRCULATING - DOWN DWG - DRAWING - NOT TO SCALE EXISTING SANITARY

PLUMBING SYMBOL LEGEND

SYMBOL	DESCRIP IION	
	 DOMESTIC COLD WATER DOMESTIC HOT WATER DOMESTIC HOT WATER RECIRCULATING SANITARY SANITARY VENT REVISION REFERENCE 	

NOTE: SOME SYMBOLS SHOWN ON THIS LEGEND MAY NOT PERTAIN TO THIS PROJECT

	[LECTR	IC WATE	ER HE	EATER	SCHEDU		
MARK	MODEL Number	CAPACITY	RECOVERY/HR 60°F RISE	KW INPUT	OUTLET TEMP.	NO. ELEMENTS/ WATTS	POWER	REMARKS
EWH-1	A.O. SMITH DEN-40	40 GALLON	31 GPH	4.5 KW	120 ° F	2/4,500	208/1/60	20½" DIA 45⅓" TALL
NOTE:	NOTE: PROVIDE WATER HEATER SHELF. ROUTE PAN DRAIN AND RELIEF PIPING TO MOP SINK.							

HOT WATER RECIRCUL	LATING PUMP SCHEDULE				
MARK	RP-1				
TYPE	INLINE				
CAPACITY(GPM)	4.5				
HEAD(FEET)	6				
MOTOR(HP)	1/25				
MOTOR(VOLTS/PHASE/HERTZ)	115/1/60				
MANUFACTURER	GRUNDFOS				
MODEL NUMBER	UP15-10B5				

PLUMBING SPECIFICATIONS

GENERAL PROVISIONS

- 1. PROVIDE ALL LABOR, MATERIAL AND EQUIPMENT FOR A COMPLETE AND PROPERLY OPERATING PLUMBING SYSTEM.
- 2. CODES AND STANDARDS: ALL PLUMBING WORK SHALL BE IN STRICT COMPLIANCE WITH THE 2007 FLORIDA PLUMBING CODE AND ALL LOCAL CODES HAVING JURISDICTION.
- 3. ALL PLUMBING WORK SHALL BE DONE IN A NEAT AND WORKMANLIKE MANNER.
- 4. CONTRACTOR SHALL SECURE AND PAY FOR ALL PERMITS AND FEES, ETC., REQUIRED FOR THE EXECUTION OF THIS WORK.
- CONTRACTOR SHALL COORDINATE HIS WORK WITH ALL OTHER TRADES BEFORE FABRICATION OR INSTALLATION.
 OFFSETS AND/OR TRANSITIONS REQUIRED SHALL BE PROVIDED WITHOUT ADDITIONAL COST. CONTRACTOR
 SHALL COORDINATE AND INSTALL HIS WORK IN A TIMELY MANNER TO PREVENT DELAYS IN THE
 CONSTRUCTION.
- 6. CONTRACTOR SHALL BE RESPONSIBLE TO REPAIR OR REPLACE DAMAGED EQUIPMENT AND/OR MATERIAL.
- 7. PROVIDE ALL MATERIALS REQUIRED TO PROPERLY SUPPORT ALL PIPING AND EQUIPMENT. PIPE HANGERS SHALL BE ADJUSTABLE TYPE AND BE SPACED IN ACCORDANCE WITH THE FLORIDA PLUMBING CODE.
- 8. PROVIDE DIELECTRIC UNIONS OR FLANGES BETWEEN COPPER AND STEEL PIPING AND BETWEEN BRASSWARE AND STEEL. DO NOT USE STEEL AND COPPER PIPING IN THE SAME SYSTEM WITHOUT SUCH ISOLATION.
- 9. PROVIDE REDUCING FITTINGS (REDUCING BUSHINGS SHALL NOT BE USED) WHERE CHANGES IN PIPE SIZES OCCUR.
- 10. THIS CONTRACTOR SHALL SUPPLY AND INSTALL ALL SERVICES THROUGHOUT THE RENOVATED AREA AND MAKE CONNECTION TO EXISTING UTILITIES. CONTRACTOR SHALL SUPPLY AND INSTALL FIXTURES, FITTINGS, VALVING AND TRIM AND MAKE READY FOR USE ALL FIXTURES, EQUIPMENT, ETC.
- 11. SEE ARCHITECTURAL DRAWINGS FOR FIXTURE LOCATIONS AND MOUNTING HEIGHTS.

BASIC MATERIALS AND METHODS

- 1. WATER PIPE AND FITTINGS INCLUDING SHUT-OFF VALVE TYPE "L" COPPER, NO-LEAD SOLDER.
- 2. WATER HAMMER ARRESTORS SHALL BE INSTALLED AT THE LOCATIONS ON THE PLANS AND IN ACCORDANCE WITH PDI STANDARD WH-201. PRODUCTS SHALL BE EQUAL TO THOSE MANUFACTURED BY PRECISION PLUMBING PRODUCTS OR SIOUX CHIEF.
- 3. VALVES: PROVIDE FULL PORT BALL VALVES TO ISOLATE EACH BRANCH LINE AND PIECE OF EQUIPMENT.
- 4. SANITARY WASTE, SANITARY VENT CAST IRON WITH NO-HUB COUPLINGS. 4" AND LARGER PIPING SHALL BE PROVIDED WITH DOUBLE BAND NO-HUB COUPLINGS. SINK & LAVATORY WASTE ARMS SHALL BE CPVC PIPING, FITTINGS AND SOLVENT WELD CEMENT. PIPING & FITTINGS SHALL BE 25-50 FLAME/SMOKE CERTIFIED. CAST IRON SHALL CONFORM TO ASTM A 888 AND CISPI 301 AND SHALL BE MARKED WITH THE TRADEMARK OF THE CAST IRON SOIL PIPE INSTITUTE AND NSF® INTERNATIONAL.
- 5. CPVC PIPING: CPVC TYPE IV, GRADE I COMPOUNDS, ASTM CELL CLASSIFICATION 23447. ALL PIPE SHALL BE SCHEDULE 40 DIMENSIONS PER OF ASTM F 441. ALL FITTINGS SHALL BE DRAINAGE PATTERN PER ASTM D 3311. ONE-STEP SOLVENT CEMENT SHALL CONFORM TO ASTM F 493. SUGGESTED MANUFACTURES: CHARLOTTE PIPING, SPEARS PIPING.
- 6. INSTALL GRAVITY LINES SLOPED AT 1/8" PER FOOT FOR PIPE 3" AND LARGER AND 1/4" PER FOOT FOR PIPE 2" AND SMALLER.

PLUMBING FIXTURES AND TRIM

- 1. ALL PLUMBING FIXTURES SHALL BE "FIRST QUALITY" AS DEFINED AND SET FORTH IN COMMERCIAL STANDARD CS77-28 AS PROMULGATED BY THE U.S. DEPARTMENT OF COMMERCE.
- 2. ALL FIXTURES ARE TO BE WHITE VITREOUS CHINA UNLESS OTHERWISE SPECIFICALLY NOTED.
- 3. FIXTURES AND FITTINGS PROPOSED SHALL BE FROM ONE MANUFACTURER AND OF SIMILAR CHARACTER IN ANY ROOM OR LOCATION. ESCUTCHEONS, HANDLES, ETC., ON THE DIFFERENT FIXTURES SHALL BE OF THE SAME DESIGN.
- 4. PROVIDE FIXTURE CARRIERS AS RECOMMENDED BY FIXTURE MANUFACTURER AND BY FIXTURE SPECIFICATIONS.
- 5. ALL CONCEALED TRAPS, PRIMERS, VALVES, CLEANOUTS, ETC. LOCATED IN TILED AREAS SHALL BE PROVIDED WITH AN ACCESS PANEL.

<u>INSULATION</u>

- 1. HOT WATER & HOT WATER RECIRCULATION FIBERGLASS, 1" THICKNESS, ASJ JACKET, DOUBLE SEALING LAP JOINT, 0.24 K AT 75°F. INSULATION AND ADHESIVES SHALL HAVE A MAXIMUM FLAME SPREAD RATING OF 25 AND A MAXIMUM SMOKE DEVELOPED RATING OF 50.
- 2. CONDENSATE PIPING SHALL BE 1/2" ELASTOMERIC INSULATION AND SHALL HAVE A MAXIMUM FLAME SPREAD RATING OF 25 AND A MAXIMUM SMOKE DEVELOPED RATING OF 50.

VALVES AND COCKS

- 1. VALVES SHALL BE FULL PORT BALL VALVES, 150 PSI SWP, 400 PSI WOG. FULL PORT BALL, BRONZE TRIM, CAST BRONZE BODY, CHROMIUM-PLATED BRASS BALL, BRONZE NON-BLOWOUT STEM, TEFLON SEAT, DOUBLE O-RING STEM SEALS, ZINC-COATED STEEL HANDLE WITH PLASTIC COATED HAND GRIP, 90 DEGREE OPERATION FROM FULL OPEN TO TIGHT SHUT-OFF.
- 2. CHECK VALVES, ROUGH BRASS, REGRINDING BRONZE DISC STOCKHAM B-345; B-309 OR EQUAL.

$\underline{\text{STERILIZATION}}$

1. DOMESTIC WATER PIPING SHALL BE THOROUGHLY FLUSHED OUT AND STERILIZED IN ACCORDANCE WITH THE FLORIDA PLUMBING CODE.

GENERAL NOTES

REFERENCE THE SPECIFICATIONS FOR MATERIAL AND EQUIPMENT INSTALLATION STANDARDS.



- 2. UTILITIES AND SERVICES INDICATED ARE TAKEN FROM VARIOUS OLD AND NEW SURVEYS,
 AS-BUILT RECORDS AND FIELD INVESTIGATIONS. UNFORESEEN CONDITIONS PROBABLY EXIST
 AND NEW WORK MAY NOT BE FIELD LOCATED EXACTLY AS SHOWN ON DRAWINGS.
 COOPERATION WITH OTHER TRADES IN ROUTING AND BURIAL DEPTHS, AS DETERMINED
 DURING CONSTRUCTION, WILL BE NECESSARY.
- 3. FIELD VERIFY EXISTING INSTALLATIONS. MODIFY EXISTING PLUMBING SYSTEMS, WHICH ARE TO REMAIN ACTIVE, TO FACILITATE RECONNECTION AND EXTENSION OF THE NEW WORK.
- 4. NOTIFY OWNER AT LEAST 72 HOURS PRIOR TO INTERRUPTING EXISTING SERVICE. SCHEDULE DISCONNECTION AND TIE-INS TO MINIMIZE DISRUPTION OF SERVICES. SERVICES ARE NOT TO BE LEFT DISRUPTED DURING NON-NORMAL CONTRACTOR WORKING HOURS.
- 5. PLANS ARE NOT COMPLETELY TO SCALE. PIPE ROUTING SHOWN IS SCHEMATIC AND IS NOT INTENDED TO INDICATE EXACT ROUTING. CONTRACTOR SHALL PROVIDE ANY ADDITIONAL OFFSETS AND FITTINGS REQUIRED FOR PROPER INSTALLATION AND TO MAINTAIN CLEARANCES. VERIFY STRUCTURAL, MECHANICAL AND ELECTRICAL INSTALLATIONS AND OTHER POTENTIAL OBSTRUCTIONS AND ROUTE PIPING TO AVOID INTERFERENCES.
- 6. CONCEAL PIPING ABOVE CEILINGS, WITHIN WALLS OR CHASES EXCEPT IN MECHANICAL ROOMS OR AS SPECIFICALLY NOTED.
- 7. SLEEVE AND/OR FIRESTOP ALL PENETRATIONS THROUGH RATED WALLS, CEILINGS, AND FLOORS WITH U/L LISTED ASSEMBLIES. FIRESTOP ASSEMBLIES SHALL BE EQUAL TO OR EXCEED THE RATING OF THE WALL, CEILING OR FLOOR. SEE ARCHITECTURAL DRAWINGS FOR FINAL FINISHES.
- 8. WHEN BEAM SLEEVE PENETRATIONS ARE NECESSARY, COORDINATE PENETRATIONS WITH ALL TRADES, THE ARCHITECT AND THE STRUCTURAL ENGINEER.
- 9. SEE ARCHITECTURAL DRAWINGS FOR FIXTURE LOCATIONS AND MOUNTING HEIGHTS.
- 10. PROVIDE AN AIR GAP, WHEN REQUIRED BY CODE, SERVING INDIVIDUAL FIXTURES, DEVICES, APPLIANCES AND APPARATUS.
- 11. ALL EXPOSED PIPE AND FITTINGS IN FINISHED AREAS SHALL BE CHROME PLATED.
- 12. PROVIDE CLEANOUTS IN ACCORDANCE WITH ALL STATE AND LOCAL CODES. INSTALL CLEANOUT WITH COVER FLUSH TO FINISH SURFACE.
- 13. COORDINATE PIPING WITH ALL ELECTRICAL EQUIPMENT (PANELS, TRANSFORMERS, ETC.)
 PRIOR TO ANY INSTALLATION. DO NOT ROUTE ANY PIPING OVER ANY ELECTRICAL PANELS
 UNDER ANY CIRCUMSTANCES. ANY PIPING RUN OVER PANELS SHALL BE RE-ROUTED AT NO
 ADDITIONAL COST.
- 14. PROVIDE SANITARY WASTE, VENT, DOMESTIC WATER, ETC. ROUGH-IN AND MAKE FINAL CONNECTIONS (TO INCLUDE PROVIDING ALL NECESSARY RELATED STOPS, VALVES, TRAPS, ETC. AND MAKE READY FOR USE) TO ALL EQUIPMENT, WHETHER FURNISHED BY THIS CONTRACTOR OR FURNISHED BY OTHERS.
- 15. LABEL ALL SANITARY, VENT & WATER PIPING EVERY 10 FEET AND WITHIN 2 FEET OF PENETRATING A WALL OR FLOOR. LABELS SHALL BE POSITIONED SO AS TO BE VISIBLE FROM A STANDING POSITION.
- 16. TWIN ELLS, CROSSES, DOUBLE "Y'S" AND DOUBLE COMBINATIONS SHALL NOT BE USED HORIZONTAL, VERTICAL, UNDERGROUND OR ABOVE GROUND SANITARY PIPING.
- 17. BALANCE THE DOMESTIC HOT WATER SYSTEM AND THE HOT WATER RECIRCULATING SYSTEM SO EACH AREA SERVED MAINTAINS AN ADEQUATE FLOW OF HOT WATER THROUGHOUT THE SUPPLY PIPING NETWORK.
- 18. CONTRACTOR SHALL PROVIDE ALL SOLENOIDS AND STARTERS NECESSARY FOR COMPLETE INSTALLATION OF ALL PUMPS.

APPLICABLE CODES

- ALL WORK SHOWN ON THE ABOVE PLUMBING/FIRE PROTECTION DRAWINGS SHALL COMPLY WITH ALL FEDERAL, STATE AND LOCAL CODES INCLUDING BUT NOT LIMITED TO THE FOLLOWING:
 - 1. FLORIDA BUILDING CODE, 2007 EDITION WITH 2009 SUPPLIMENTS
 - 2. FLORIDA PLUMBING CODE, 2007 EDITION WITH 2009 SUPPLIMENTS
 - 3. N.F.P.A. 101, LIFE SAFETY CODE, 2003 EDITION

DRAWING INDEX

SHEET	DESCRIPTION	ISSUED
P0.1	SPECIFICATIONS, NOTES AND SHEET INDEX - PLUMBING	YES
P0.2	FIXTURES AND FIXTURE SPECIFICATIONS	YES
P2.1	PARTIAL SECOND FLOOR - NEW WORK - SANITARY - PLUMBING	YES
P2.2	PARTIAL SECOND FLOOR - NEW WORK - WATER - PLUMBING	YES
P4.1	DETAILS - PLUMBING	YES
P5.1	RISER DIAGRAM - PLUMBING	

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ISSUE DATE: ???

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SOUTH

BAPTIST MEDICAL CENTER INTERSTATE 95 EXIT 335 14550 OLD ST. AUGUSTINE ROAD JACKSONVILLE, FLORIDA 32258

TIMESHARE MOB2 SUITE #2371

SPECIFICATIONS, NOTES
AND SHEET INDEX
PLUMBING

SCALE: AS NOTED

LOG NO. T:\Baptist Health...\Drawings\

C & A FN: 3943

Est. Project GSF:

BOMA SF:

SHEET NUMBER:

PO. 1

\811114-

PLUMBING FIXTURES

PLUMBING SCHEDULES

1650 Prudential Drive Suite 200 Phone: 904-306-9111 Fax: 904-306-9117 ENGINEERING FOR ARCHITECTURE WWW.tlc-engineers.com © Copyright 2011 TLC Engineering for Architecture, Inc. COA 15 TLC NO: 811114

ADA - MEETS FLORIDA ACCESSIBILITY CODE

VB - VACUUM BREAKER

CT - COUNTER TOP

WH - WALL HUNG

Jacksonville, Florida 32207

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BAPTIST MEDICAL CENTER INTERSTATE 95 EXIT 335 14550 OLD ST. AUGUSTINE ROAD JACKSONVILLE, FLORIDA 32258

TIMESHARE MOB2 SUITE #2371

SHEET NAME:

FIXTURES & FIXTURE SPECIFICATIONS PLUMBING

SCALE: AS NOTED

LOG NO. T:\Baptist Health...\Drawings\

C & A FN: 3943

Est. Project GSF:

BOMA SF:

SHEET NUMBER:

P0.2

WC-1 WATER CLOSET, FLUSH TANK, FLOOR MOUNTED. FLOOR OUTLET. ADA

BARRIER FREE, VITREOUS CHINA, FLOOR MOUNTED, FLOOR OUTLET, SIPHON JET, AND ELONGATED CLOSET BOWL WATER CLOSET. WATER CLOSET SHALL BE INSTALLED SO TOP OF SEAT IS BETWEEN 17" AND 19" ABOVE FINISHED FLOOR.

CONTOURED SEAT SHALL BE EXTRA HEAVY SOLID PLASTIC WITH OPEN FRONT LESS COVER. SEAT SHALL INCLUDE STAINLESS STEEL SELF SUSTANING CHECK HINGE FEATURE.

BASIS OF DESIGN

CHINA - KOHLER - NO. K-3481 SEAT - BEMIS - NO. 1655-SS/C

L-1 LAVATORY, WALL HUNG, ADA

BARRIER FREE, VITREOUS CHINA, WALL HUNG LAVATORY, 211/4"X181/8", WITH FRONT OVERFLOW, SELF DRAINING DECK AREA AND CONTOURED BACK AND SIDE SPLASH PANELS, PROVIDE FIXTURE PUNCH FOR COMBINATION FITTING ON 4" CENTERS AND CONCEALED ARM CARRIER SUPPORT.

MOUNT AT 34" ABOVE FINISHED FLOOR.

4" WIDESPREAD COMBINATION CHROME PLATED BRASS FAUCET, WITH RIGID GOOSENECK NOZZLE, 2.2 GPM LAMINAR FLOW HEAD, LESS AERATOR WITH END TRIM. VANDAL RESISTANT 4" WRIST BLADES HANDLES WITH COLOR CODED INDEXES AND RENEWABLE SEATS IN MONEL, OUTLET OF SPOUT SHALL BE MINIMUM 5" ABOVE RIM OF FIXTURE.

CHROME PLATED CAST BRASS GRID STRAINER WITH 11/4" O.D. OFFSET TAILPIECE, CHROME PLATED 17 GAUGE 11/2" BRASS P-TRAP WITH CLEANOUT PLUG AND SLIP NUTS.

 $\frac{1}{2}$ " I.P.S. CHROME PLATED ANGLE SUPPLIES, LOOSE KEY STOPS, ESCUTCHEONS AND 1/4" CHROME PLATED COPPER EXTENSION TUBES.

PROVIDE MIXING VALVE TO CONTROL HOT WATER MAXIMUM TEMPERATURE AT

PROVIDE P-TRAP, TAILPIECE, AND WATER SUPPLIES WITH PREWRAPPED SEAMLESS MOLDED CLOSED CELL VINYL INSULATION WITH FLEXIBLE COLLARS TO ALLOW PIPE CONNECTION. PROTECTIVE WRAP SHALL INCLUDE HOT AND COLD ANGLE STOPS AND WATER SUPPLY COVERS OF SAME MATERIAL.

LAVATORY SUPPORT SYSTEM WITH CONCEALED ARMS: COATED STEEL UPRIGHTS WITH WELDED FEET, CAST IRON ADJUSTABLE HEADERS, STEEL SLEEVES, ALIGMENT TRUSS AND FASTENERS.

BASIS OF DESIGN

CHINA - ZURN - NO. Z5340 FAUCET - CHICAGO - NO. 895-317E29CP MIXING VALVE - WATTS - USG-P STRAINER/TRAP - MCGUIRE - NO. 155WC/PW 2150WC SUPPLIES - MCGUIRE - NO. 170LK CARRIER - J.R. SMITH

S-1 SINK, SINGLE COMPARTMENT, EXAM

SINGLE COMPARTMENT SELF RIMMING SINK CONSTRUCTED OF TYPE 302 18-8 STAINLESS STEEL, 15" X 17" X 7" DEEP. INTERIOR AND TOP SURFACES SHALL BE POLISHED TO A HIGH LUSTER FINISH. PROVIDE SINK WITH STAINLESS STEEL CRUMB CUP STRAINER. PROVIDE FIXTURE PUNCH FOR COMBINATION FITTING ON 8" CENTERS.

8" WIDESPREAD COMBINATION CHROME PLATED BRASS FAUCET, WITH RIGID GOOSENECK NOZZLE LESS AERATOR WITH END TRIM AND 2.0 GPM LAMINAR FLOW REGULATOR, VANDAL RESISTANT 4" WRIST BLADES HANDLES WITH COLOR CODED INDEXES AND RENEWABLE SEATS IN MONEL, OUTLET OF SPOUT SHALL BE MINIMUM 5" ABOVE RIM OF FIXTURE.

CHROME PLATED CAST BRASS STRAINER WITH $1\frac{1}{2}$ " O.D. TAILPIECE. CHROME PLATED 17 GAUGE 11/2" BRASS P-TRAP WITH CLEANOUT PLUG AND SLIP NUTS.

1/2" I.P.S. CHROME PLATED ANGLE SUPPLIES, WHEEL HANDLE STOPS, ESCUTCHEONS AND 1/4" CHROME PLATED COPPER EXTENSION TUBES.

BASIS OF DESIGN

SINK - ELKAY - NO. LR1517 STRAINER - KOHLER - K-8801 FAUCET - CHICAGO - NO. 786-GN2-FCXKCP TRAP - MCGUIRE - NO. 8912 SUPPLIES - MCGUIRE - NO. 170

S-2 SINK, SINGLE COMPARTMENT, LOUNGE, ADA

SINGLE COMPARTMENT SELF RIMMING SINK CONSTRUCTED OF TYPE 302 18-8 STAINLESS STEEL, 19" X 19" X 51/2" DEEP. INTERIOR AND TOP SURFACES SHALL BE POLISHED TO A HIGH LUSTER FINISH. PROVIDE SINK WITH TWO STAINLESS STEEL CRUMB CUP STRAINERS. PROVIDE 3 HOLE PUNCH FOR FAUCET. PROVIDE DRAIN HOLE IN REAR, CENTER ON BOWL.

SINGLE LEVER CHROME PLATED BRASS FAUCET, WITH SIDE SPRAY, 8" FACE PLATE, AND 2.0 GPM AERATOR.

CHROME PLATED CAST BRASS STRAINERS (2) WITH 11/2" O.D. TAILPIECE, P-TRAP WITH CLEANOUT PLUG AND SLIP

1/2" I.P.S. CHROME PLATED ANGLE SUPPLIES, WHEEL HANDLE STOP, ESCUTCHEON AND 1/4" CHROME PLATED COPPER EXTENSION TUBE.

BASIS OF DESIGN

SINK - ELKAY - NO. LRAD1919 STRAINER - ELKAY - LK-35 FAUCET - CHICAGO - NO. 2301-8CP TRAP - MCGUIRE - NO. 8912 SUPPLIES - MCGUIRE - NO. 170

SA-# SA-1 TO SA-6 SHOCK ARRESTER

HEAVY DUTY BALANCED EXPANSION BELLOWS WITH PRESSURIZED COMPRESSION CHAMBER, HYDRAULIC FLUID INTERIORWITH THREADED CONNECTION. ARRESTORS MAY BE INSTALLED IN VERTICAL AND HORIZONTAL POSITION.

SHOCK ARRESTORS SHALL BE INSTALLED ON ALL FLUSH VALVE ACTIVATED DEVICES, SHOWER VALVES, ANY QUICK-CLOSE FIXTURES, END OF THE MAIN LINE PIPING, TOP OF MAIN RISER PIPING AND WHERE INDICATED ON THE DRAWINGS.

INSTALATION SHALL FOLLOW MANUFACTURER AND PDI RECOMMENDATIONS.

THE ARRESTOR SHALL BE FULLY GUARANTEED FOR ENTIRE SYSTEM LIFE.

BASIS OF DESIGN

J.R. SMITH - HYDROTROL WATER HAMMER ARRESTER SA-1 - 5005, SA-2 - 5010, SA-3 - 5020, SA-4 - 5030, SA-5 - 5040, SA-6 - 5050

REFRIGERATOR, ICE MAKER

PROVIDE A COLD WATER ANGLE STOP UNDER LOUNGE SINK FOR REFRIGERATOR ICE MAKER CONNECTION.

PROVIDE 3/8" COPPER TUBING FROM THE ANGLE STOP TO THE TASTE AND ODOR FILTER. MAKE FINAL CONNECTION TO THE REFRIGERATOR WITH A 12' COIL OF COPPER PIPING BEHIND THE REFRIGERATOR.

MOUNT THE TASTE & ODOR FILTER IN THE CABINET WITH EASY ACCESS FOR REPLACEMENT OF THE FILTER.

INSTALL THE COPER TUBING IN A PROFESSIONAL MANNER.

BASIS OF DESIGN

FILTER - EVERPURE - MODEL - QL3-BH2

	P L U M B I N G	FΙ	X T U	RE	S C	HEDULE
		ROUG	GH-IN SIZ	ES IN IN	ICHES	
MARK	TYPE OF PLUMBING FIXTURE	COLD WATER	HOT WATER	SAN. VENT	SAN./ WASTE	REMARKS
WC-1	WATER CLOSET, ADA	1/2"		2"	3"	FM, FO, FT, 1.6 GPF
L-1	LAVATORY, ADA	1/2"	1/2"	2"	2"	WH, FC, GN, WB
S-1	SINK, EXAM	1/2"	1/2"	2"	2"	SS, WB, GN
S-2	SINK, LOUNGE	1/2"	1/2"	2"	2"	SS, SL, GN
SA-1	SHOCK ARRESTOR					PER SCHEDULE
IM- 1	REFRIGERATOR ICE MAKER CONNECTION	1/2"				PER SPECIFICATION

S H O C K A	R R	EST	E R	S C	H E D	ULE
P.D.I. UNITS	SA-1	SA-2	SA-3	SA-4	SA-5	SA-6
FIXTURE UNITS	1-11	12-32	33-60	61-113	114-154	115-330

GN - GOOSENECK FAUCET

SA - WATER HAMMER ARRESTOR

WB - WRIST BLADES

SS - STAINLESS STEEL

FO - FLOOR OUTLET

FM - FLOOR MOUNTED

FC - FLOOR CARRIER

FT - FLUSH TANK

ABBREVIATIONS:

SEAL

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TIMESHARE MOB2 SUITE #2371

SHEET NAME:

PARTIAL SECOND FL.
NEW WORK-SANITARY
PLUMBING

SCALE: AS NOTED

LOG NO. T:\Baptist Health...\Drawings\


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Est. Project GSF:

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ET NUMBER:

P2.1



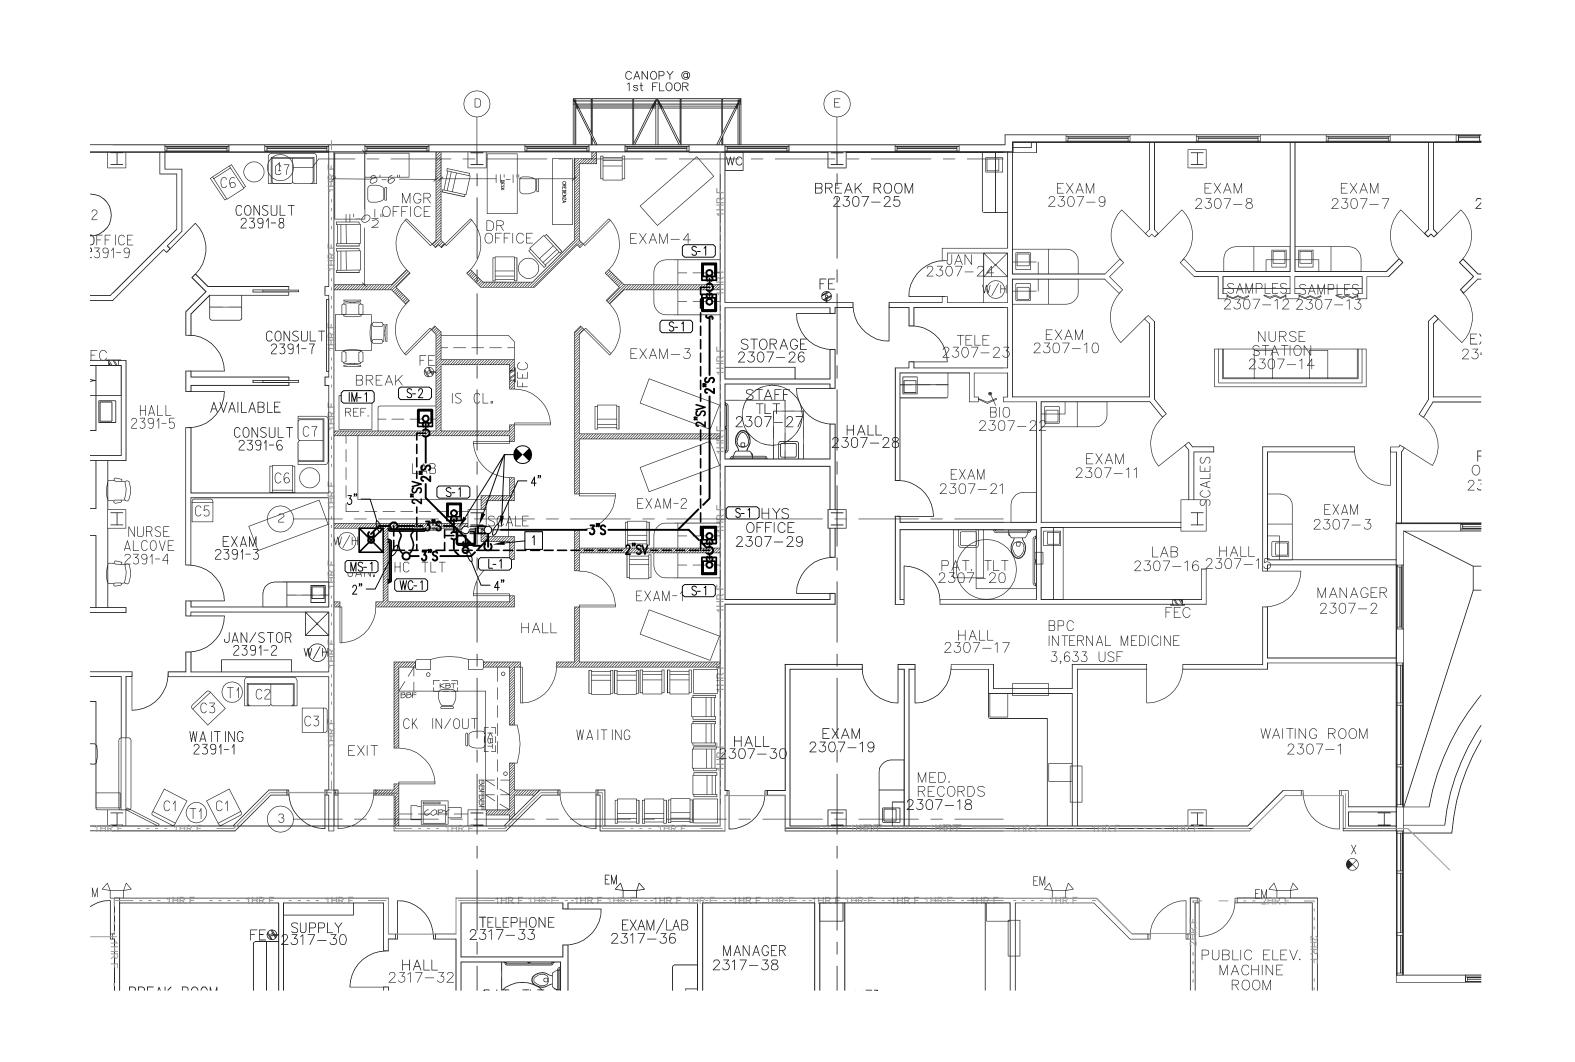

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TIMESHARE MOB2 SUITE #2371

SHEET NAME:

PARTIAL SECOND FL.
NEW WORK - WATER
PLUMBING

SCALE: AS NOTED

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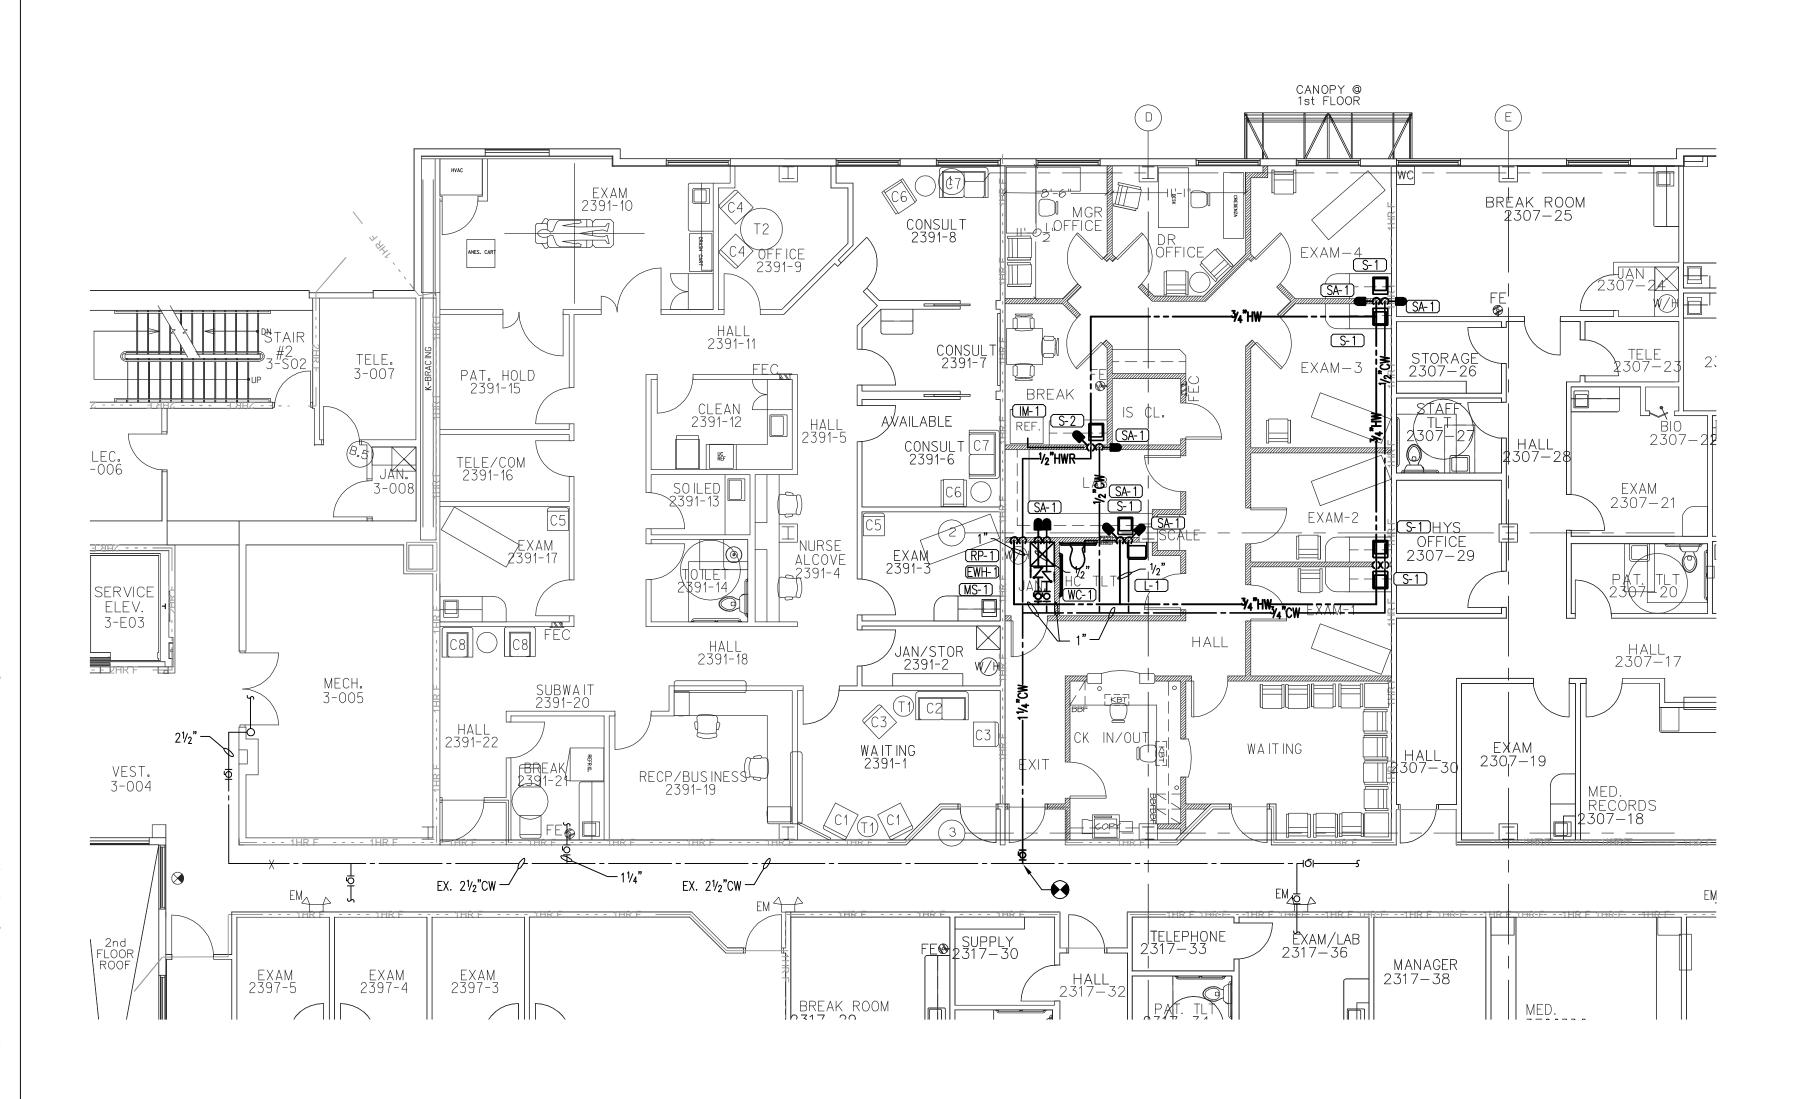
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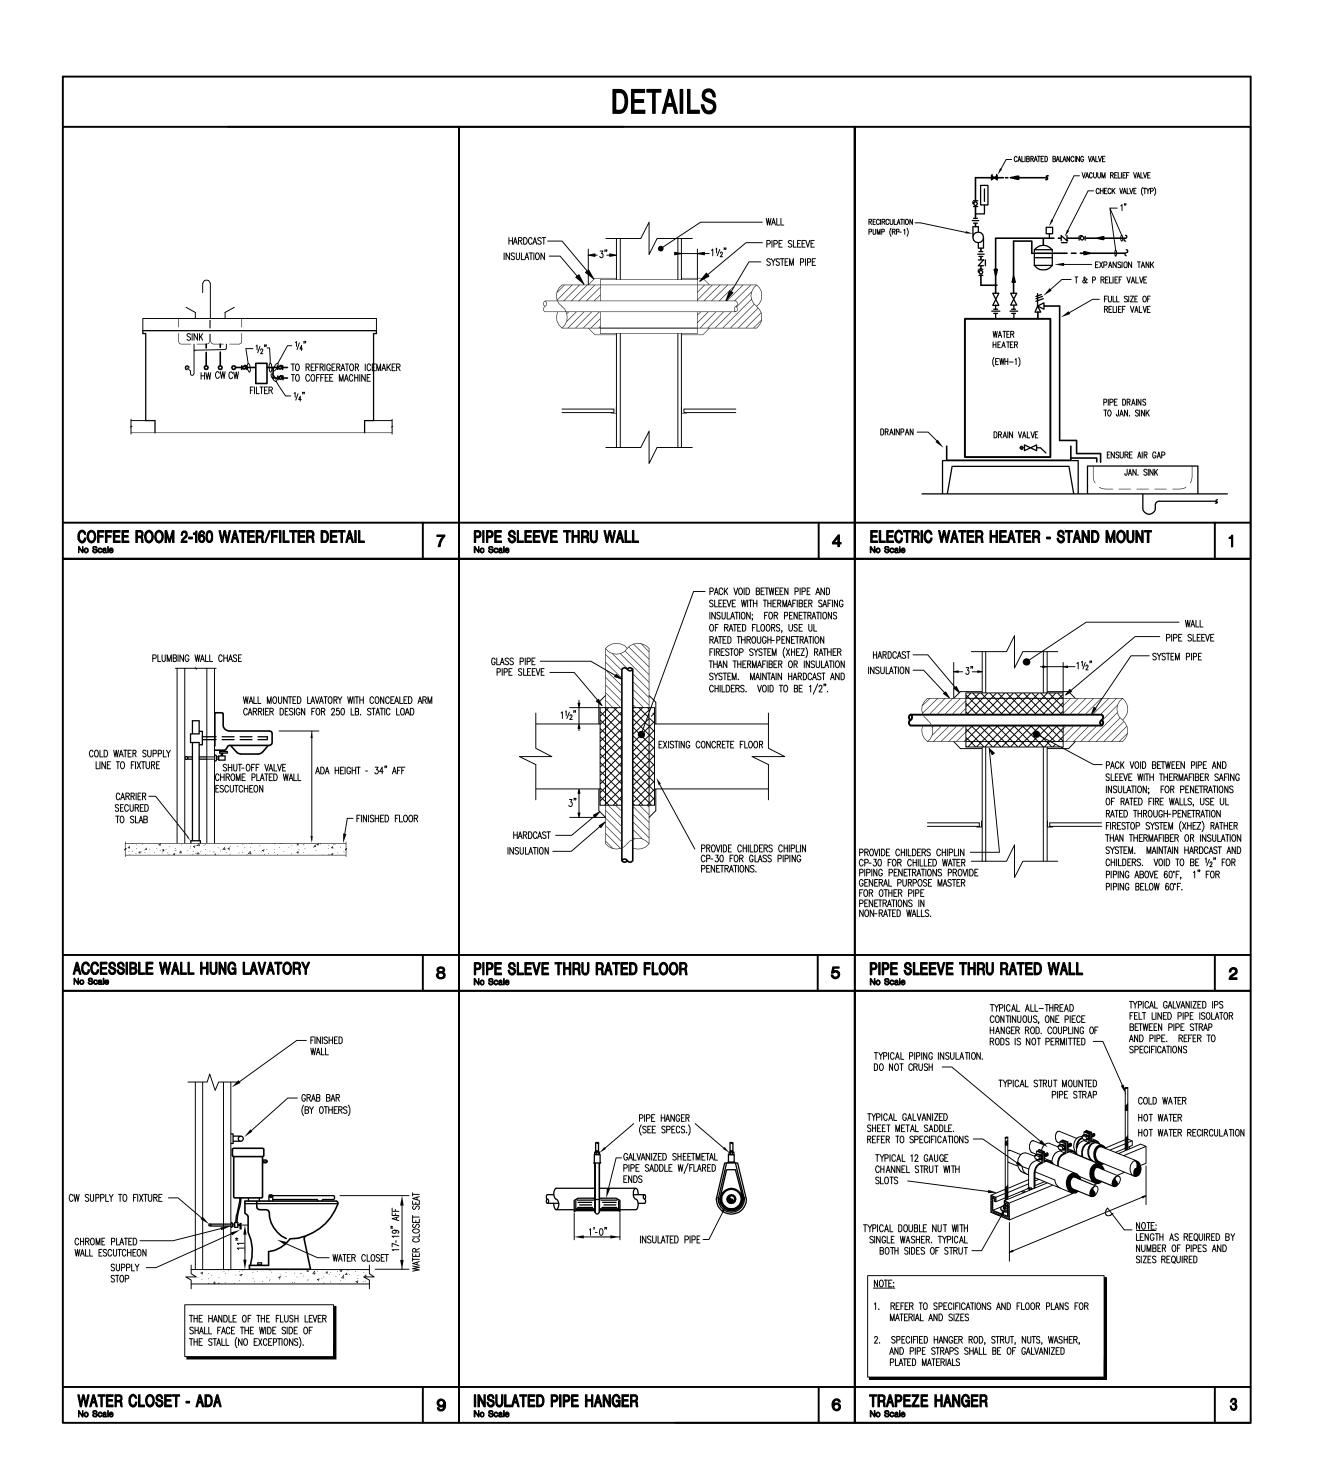
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P2.2









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SHEET NAME:	
DETAILS	
PLUMBING	

SCALE: AS NOTED

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C & A FN: 3943

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P4.

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TIMESHARE MOB2 SUITE #2371

SHEET NAME:

RISER DIAGRAM SANITARY PLUMBING

SCALE: AS NOTED


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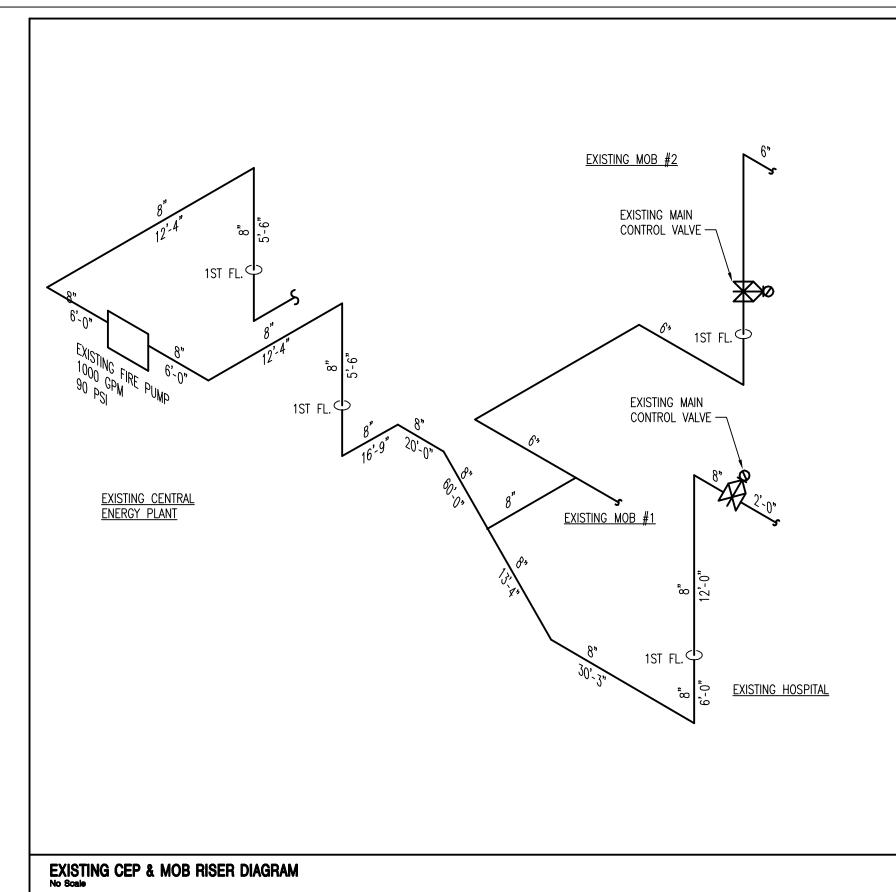


RISER DIAGRAM — SANITARY — PLUMBING
SCALE: NTS

'0.1.dwg 10/27/2011 10:10:45 AM mike.giordano

2 Timeshare TI\CAD-MEP\Sheets

\2011-Jobs\811114-BMCS MOB

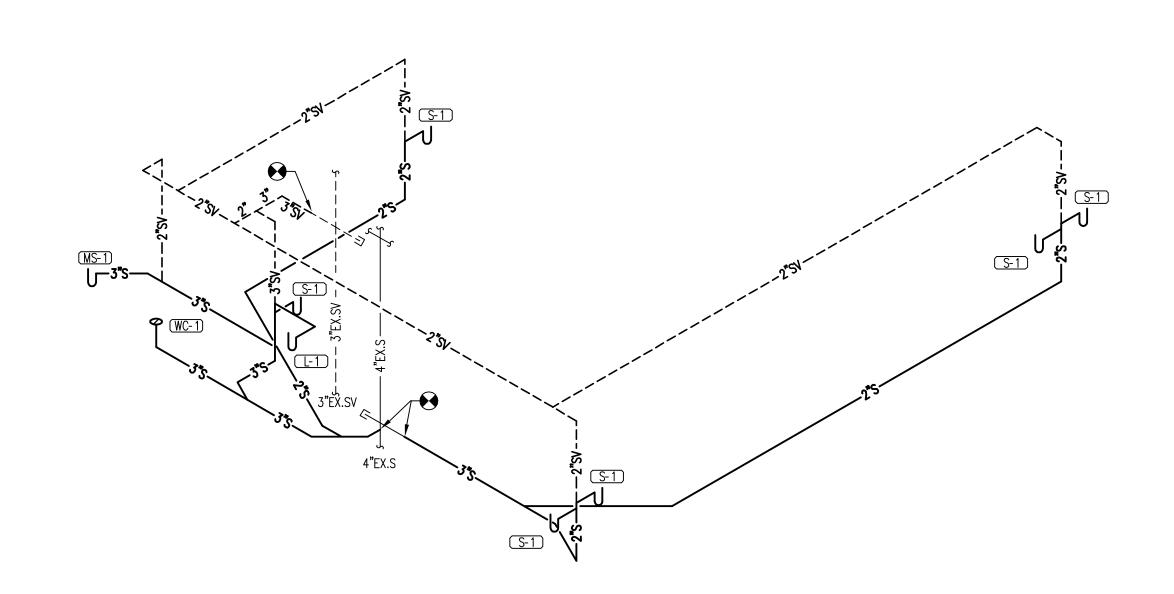

FIRE PROTECTION LEGEND

- STANDPIPE

SYMBOL DESCRIPTION - NEW FIRE MAIN PIPING NEW SPRINKLER PIPING

ø₩

- STANDPIPE WITH FIRE DEPARTMENT VALVE - SPRINKLER AND DRAIN RISER - CONTROL VALVE W/TAMPER SWITCH

- FLOW SWITCH - CHECK VALVE - BALL VALVE

- GATE VALVE **-сфумф**э-- BACKFLOW PREVENTOR ✓ OR 🌣 - FIRE DEPARTMENT SIAMESE INLET CONNECTION

- FIRE DEPARTMENT INLET OR TEST HEADER CONNECTION - ROOF HYDRANT

HVC ├─ OR O HVC - HYDRANT VALVE CONTROLS **Ø**₩ PIV - POST INDICATOR VALVE W/TAMPER SWITCH

- PRESSURE RELIEF VALVE **FVC** - FIRE VALVE CABINET F.C. \vdash - FLUSHING CONNECTION - HYDRAULIC REFERENCE NODE

- REVISION REFERENCE

- CONNECTION TO EXISTING

NOTE: SOME SYMBOLS SHOWN ON THIS LEGEND MAY NOT PERTAIN TO THIS PROJECT

EXISTING FIRE AND JOCKEY PUMP SCHEDULE

	SYSTEM	TYPE	MANUFACTURER	MODEL NO.	FLOW (GPM)	PRESSURE BOOST (PSI)	H.P.	VOLTAGE	MOTOR R.P.M.
					(OI M)	D0031 (F3I)			1/-1 -M-
	FIRE PUMP	ELECTRIC	AURORA	481-BF	1000	90	75	460/3/60	3560
	JOCKEY PUMP	ELECTRIC		-	-	-	-	-	-
-	REMARKS:								

EXISTING FIRE PROTECTION PUMP TEST DATA

RPM

3577

3571

3562

3559

GPM

0

511

1029

1546

DATE - TIME -	11-5-10	FLOW	DISCHARGE	SUCTION	NET	HOSES	STREAM	PITOT	FLOW	COI
		POINT	PSI	PSI	PSI	FLOWING	SIZE	PSI	GPM	PSI
		1	173	60	113	0		-	0	112.1
PUMP DATA		2	166	57	109	1	1.75"	32	515	108.5
TYPE	ELECTRIC	3	148	52	96	2	1.75"	32	1029	96.0
FLOW	1000 GPM	4	113	45	68	3	1.75"	32	1544	68.1
PRESSURE	90 PSI									
RPM	3562									
HP	75									
VOLTAGE	460/3/60									

TEST CONDUCTED BY - W.W GAY FIRE & INTEGRATED SYSTEMS, INC.

AUTHORITY HAVING JURISDICTION: AHCA AND CITY OF JACKSONVILLE FIRE MARSHALL

WATER IS PROVIDED BY THE CITY OF JACKSONVILLE AND IS TREATED FOR MICROBIOLOGICAL CONTAMINATES. ALL WATER IS ROUTED THROUGH ON-SITE MAIN BACKFLOW PREVENTERS.

APPLICABLE CODES

ALL WORK SHOWN ON THE ABOVE PLUMBING/FIRE PROTECTION DRAWINGS SHALL COMPLY WITH ALL FEDERAL, STATE AND LOCAL CODES INCLUDING BUT NOT LIMITED TO THE FOLLOWING:

- 1. FLORIDA BUILDING CODE, 2007 EDITION WITH 2009 SUPPLIMENTS
- 2. FLORIDA FIRE CODE, 2007 EDITION WITH 2009 SUPPLIMENTS
- 3. N.F.P.A. 13, STANDARD FOR INSTALLATION OF SPRINKLER SYSTEMSS, 2002 EDITION,
- 4. N.F.P.A. 101, LIFE SAFETY CODE, 2003 EDITION

DRAWING INDEX

SHEET	DESCRIPTION	ISSUED
F0.1	LEGEND, SCHEDULES, NOTES AND INDEX - FIRE PROTECTION	YES
F0.2	SPECIFICATIONS - FIRE PROTECTION	YES
F2.1	PARTIAL SECOND FLOOR - NEW WORK - FIRE PROTECTION	YES
F4.1	DETAILS - FIRE PROTECTION	YES



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TIMESHARE MOB2 SUITE #2371

SHEET NAME: LEGEND, SCHEDULES NOTES & INDEX FIRE PROTECTION

SCALE: AS NOTED

LOG NO. T:\Baptist Health...\Drawings\

C & A FN: 3943

Est. Project GSF:

BOMA SF:

SHEET NUMBER:

FAC 61G15-32 FIRE PROTECTION CRITERIA

61G15-32.003

(1) OVERALL DESCRIPTION

THIS JOB IS A TENANT INFILL OF AN EXISTING SHELLED OUT MEDICAL OFFICE BUILDING (MOB). WITH AN EXISTING, ORDINARY HAZARD GROUP 2, WET PIPE FIRE SPRINKLER SYSTEM, DESIGNED PER NFPA 13, 2002 EDITION. NEW SPRINKLER HEADS WILL BE LOCATED TO ACCOMIDATE THE NEW, LIGHT HAZARD OCCUPANCY, FLOOR PLAN. THE EXISTING BUILDING IS SUPPLIED WITH A 6" STANDPIPE SYSTEM IN EACH STAIRWELL AND THE STANDPIPE IS SUPPLIED BY AN EXISTING FIRE PUMP.

THE BUILDING IS LOCATED OFF OF OLD ST. AUGUSTINE ROAD IN JACKSONVILLE, FLORIDA.

(2) ACCEPTANCE TESTING

THE FIRE SPRINKLER ACCEPTANCE TESTING SHALL BE PROVIDED PER NFPA 13, 2002 EDITION.

(3) OCCUPANCY CLASSIFICATION

THE EXISTING CLAISSIFICATION IS ORDINARY HAZARD GROUP 2. THE OCCUPANCY CLASSIFICATION OF NEW WORK WILL BE LIGHT HAZARD UNLESS OTHERWISE SPECIFIED ON

(4) PREPARATION OF DOCUMENTS

THE RENOVATION OF THE SPRINKLER SYSTEM FOR THE BUILDING IS A WET PIPE SYSTEM, DESIGNED PER NFPA 13, 2002 EDITION, FOR LIGHT HAZARD. THE SYSTEM WILL INCLUDE USING STEEL, SCHEDULE 40 PIPING LOCATED ABOVE THE CEILING. TO SPRINKLER HEADS LOCATED IN THE CEILING, ANY EXPOSED PIPING WILL BE STEEL, SCHEDULE 40. SPRINKLERS WILL BE 'QUICK RESPONSE'

(5) STRUCTURAL SUPPORT

STRUCTURAL SUPPORT AND STRUCTURAL OPENINGS FOR THE FIRE PROTECTION SYSTEM INCLUDING LIVE AND DEAD LOADS HAVE BEEN COORDINATED WITH THE STRUCTURAL ENGINEER. STEEL SLEEVES WILL BE SET PRIOR TO CONCRETE PLACEMENT, TO PROVIDE FOR PENETRATIONS OF FIRE PROTECTION PIPING THROUGH THE FLOORS OR ROOF STRUCTURE. CORE DRILLING WILL BE ALLOWED FOR CMU WALL PENETRATIONS FOR FIRE PROTECTION PIPING AS MAY BE REQUIRED. ALL PENETRATIONS WILL BE PROPLERLY FIRE-CAULKED, AS REQUIRED.

61G15-32.004

2(a) POINT OF SERVICE:

SEE RISER

2(b) GOVERNING STANDARDS:

SYSTEM DESIGN AND INSTALLATION SHALL COMPLY WITH 2002 EDITION OF NFPA 13, NFPA 25. AS WELL AS THE 2007 FLORIDA BUILDING CODE AND THE 2007 FLORIDA FIRE PREVENTION CODE

2(c) OCCUPANCY CLASSIFICATIONS:

THE INFILL AREA WILL BE USED AS OFFICE SPACE AND SHALL HAVE A LIGHT HAZARD OCCUPANCY.

2(d) <u>DESIGN APPROACH</u>:

SYSTEM WILL BE FULLY-AUTOMATIC, WET PIPE SYSTEM. AREAS OF THE BUILDING SHALL BE DESIGNED FOR 0.1 GPM/SF WITH A MAXIMUM COVERAGE AREA OF 225 SF PER HEAD AND MAXIMUM HEAD SPACING OF 15 FEET.

2(e) WATER SUPPLY CHARACTERISTICS:

WATER SUPPLY IS PROVIDED BY AN ELECTRIC FIRE PUMP ON EMERGENCY POWER.

2(q) VALVING AND ALARM REQUIREMENTS:

SPRINKLER SYSTEM IS PROVIDED WITH EXISTING FLOW AND TAMPER SWITCH.

2(h) MIC RISK EVALUATION:

WATER SHALL BE TESTED IN ACCORDANCE WITH NEPA FOR MIC. TEST SHALL BE RECORDED AND SUBMITTED TO THE ENGINEER OF RECORD AND JACKSONVILLE FIRE MARSHAL'S OFFICE.

2(i) BACKFLOW PREVENTION DETAILS:

EXISTING.

2(j) COMPONENT SPECIFICATIONS:

QUALITY AND PERFORMANCE OF ALL YARD AND INTERIOR FIRE PROTECTION COMPONENTS SHALL MEET THE REQUIREMENTS OF 2002 NFPA 13. UNDERGROUND PIPING, VALVES, SWITCHES, AND OTHER COMPONENTS TO BE UL AND FM LISTED MATERIALS.

FIRE PROTECTION SPECIFICATIONS

GENERAL PROVISIONS

- PROVIDE DESIGN, LABOR, MATERIAL AND EQUIPMENT FOR A COMPLETE AND PROPERLY OPERATING FIRE PROTECTION
- 2. THE FIRE PROTECTION SYSTEMS SHALL BE DESIGNED AND INSTALLED BY A STATE OF FLORIDA FIRE PROTECTION CONTRACTOR PER THE CONTRACT DOCUMENT DRAWINGS.
- CODES AND STANDARDS. THE FIRE SPRINKLER PROTECTION SYSTEMS INSTALLATION. FLUSHING AND TESTING SHALL COMPLY WITH THE REQUIREMENTS OF NFPA 13 AND ALL LOCAL CODES HAVING JURISDICTION.
- 4. PIPE THREAD PATTERN. ALL THREADS SHALL BE IN ACCORDANCE WITH LOCAL FIRE DEPARTMENT SPECIFICATIONS AND NFPA 1963. 2003 REVISION.
- 5. UL/FM APPROVAL. ALL EQUIPMENT. VALVES. COUPLINGS. HANGERS AND DEVICES SHALL BE APPROVED BY UNDERWRITERS. LABORATORY (UL) OR FACTORY MUTUAL (FM) FOR USE IN FIRE PROTECTION SERVICE.
- 6. ALL FIRE PROTECTION WORK SHALL BE DONE IN A NEAT AND WORKMAN-LIKE MANNER.
- CONTRACTOR SHALL SECURE AND PAY FOR ALL PERMITS AND FEES, ETC. REQUIRED FOR THE EXECUTION OF THIS
- 8. CONTRACTOR SHALL COORDINATE WORK WITH OTHER TRADES BEFORE FABRICATION OR INSTALLATION. OFFSETS AND/OR TRANSITIONS REQUIRED SHALL BE PROVIDED WITHOUT ADDITIONAL COST. CONTRACTOR SHALL COORDINATE AND INSTALL WORK IN A TIMELY MANNER TO PREVENT DELAYS IN THE CONSTRUCTION.
- 9. CONTRACTOR SHALL BE RESPONSIBLE TO REPAIR OR REPLACE DAMAGED EQUIPMENT AND/OR MATERIAL.
- 10. PIPING SHOP DRAWINGS. SUBMIT $\frac{1}{3}$ "=1'-0" SCALE PIPING SHOP DRAWINGS. SHOP DRAWINGS SHALL INCLUDE SPRINKLER PIPING CUT LENGTHS. OFFSETS. FITTINGS AND DEVICES. ELEVATIONS. HANGER LOCATIONS. SPRINKLER HEAD COUNT BY TYPE. ELEVATION SECTIONS AND OTHER INSTALLATION INFORMATION. DEMONSTRATE COMPLIANCE WITH THE REQUIREMENTS OF NFPA-13 REGARDING DENSITY, AREA OF APPLICATION AND MAXIMUM COVERAGE PER
- 11. COORDINATE ALL PIPE ROUTING WITH ALL OTHER TRADES PRIOR TO INSTALLATION. ROUTE ALL PIPING TO AVOID DUCTWORK, PIPING AND BUILDING STRUCTURE.

BASIC MATERIALS AND METHODS

- GENERAL. ONLY THE FOLLOWING MATERIALS DESIGNED FOR 175 PSIG CWP SHALL BE USED FOR FIRE PROTECTION PIPING UNLESS SPECIFICALLY INDICATED OTHERWISE. ALL PIPING MATERIALS SHALL HAVE A CORROSION RESISTANCE RATING (CCR). OF 1.0 OR GREATER.
- 2. PIPE. 2 INCH OR SMALLER PIPE. AND ALL THREADED PIPING SHALL BE BLACK STEEL. SCHEDULE 40. ASTM A-53. 2-1/2 INCH AND LARGER PIPE MAY BE BLACK STEEL. SCHEDULE 10. ASTM A-135.
- FITTINGS. SCHEDULE 40 BLACK STEEL PIPE SHALL BE JOINED BY MECHANICAL COUPLINGS. THREADED OR WELDED FITTINGS. SCHEDULE 10 BLACK STEEL PIPE SHALL BE JOINED BY ROLLED GROOVE COUPLINGS OR WELDED FITTINGS ONLY. WELDED BRANCH CONNECTIONS WHICH ARE AT LEAST 2 NOMINAL PIPE SIZES SMALLER THAN THE MAINS ARE PERMITTED. THREADED FITTINGS ARE ACCEPTABLE ONLY FOR PIPING 2 INCHES AND SMALLER.
- HANGERS. ALL HANGER SPACING SHALL COMPLY WITH THE REQUIREMENTS OF NFPA-13.
- 5. SPRINKLER HEAD LOCATION. INSTALL SPRINKLER HEADS IN THE CENTER OF THE CEILING TILES FOR SUSPENDED CEILING APPLICATIONS.
- 6. HYDROSTATIC TESTS. ABOVE GROUND AND BELOW GROUND PIPING SYSTEMS SHALL BE HYDROSTATICALLY TESTED AT NOT LESS THAN 200 PSI PRESSURE. OR AT 50 PSI IN EXCESS OF THE MAXIMUM PRESSURE. WHICHEVER IS GREATER. FOR A PERIOD OF 2 HOURS. THE TEST PRESSURE SHALL BE READ FROM A GAUGE LOCATED AT THE LOW ELEVATION POINT OF THE INDIVIDUAL SYSTEM OR PORTION OF THE SYSTEM BEING TESTED. THE SPRINKLER PIPING SHALL NOT HAVE LEAKAGE EXCEEDING THE AMOUNTS SPECIFIED IN NFPA 24. LEAKAGE QUANTITIES SHALL BE DETERMINED BY PUMPING AT THE SPECIFIED TEST PRESSURE FROM A CALIBRATED CONTAINER. REPAIR LEAKING JOINTS AND RETEST AS NECESSARY UNTIL ALL SYSTEMS HAVE BEEN TESTED. TEST THE PIPING BETWEEN THE CHECK VALVE IN THE FIRE DEPARTMENT INLET PIPE AND THE OUTSIDE CONNECTION THE SAME AS THE BALANCE OF THE SYSTEM.

FIRE PROTECTION VALVES AND ACCESSORIES

- QUICK-RESPONSE UPRIGHT SPRINKLERS. SPRINKLER HEADS SHALL BE MANUFACTURED WITH UPRIGHT DEFLECTORS
- 2. QUICK RESPONSE SEMI-RECESSED SPRINKLERS. SPRINKLER HEADS SHALL BE MANUFACTURED WITH PENDANT DEFLECTOR FOR INSTALLATION BELOW THE BRANCH LINE WITH CHROME-PLATED FINISH . CENTRAL GB-QR OR VIKING MICROFAST MODEL M WITH MODEL F-1 ESCUTCHEON.
- QUICK-RESPONSE CONCEALED SPRINKLERS. SPRINKLER HEADS SHALL BE MANUFACTURED WITH PENDANT DEFLECTOR FOR INSTALLATION BELOW THE BRANCH LINE WITH WHITE FINISH . VIKING "MIRAGE". ONLY.
- SPRINKLER CAGE GUARD. PROVIDE SPRINKLER HEAD OPEN-WIRE CAGE GUARD TO PROTECT HEADS FROM INJURY. CAGE WIRE SHALL BE CADMIUM-PLATED STEEL . CENTRAL SPRINKLER GUARD A-1 OR VIKING MODEL A-1 SPRINKLER GUARD.

GENERAL NOTES

- 1. FINAL INSPECTION AND APPROVAL BY LOCAL FIRE MARSHAL AND ARCHITECT/ENGINEER.
- 3. SPRINKLER SHOP DRAWINGS AND MATERIAL SUBMITTALS SHALL BE SUBMITTED TO THE ARCHITECT/ENGINEER AND STATE FIRE MARSHAL
- AND SHALL BE APPROVED PRIOR TO ANY INSTALLATION. 4. PIPE ROUTING SHOWN IS EXISTING. IT IS THE RESPONSIBILITY OF

THIS CONTRACTOR TO PROVIDE ANY ADDITIONAL OFFSETS REQUIRED

FOR PROPER INSTALLATION AND COORDINATION WITH OTHER TRADES.

5. REFER TO ARCHITECTURAL REFLECTED CEILING PLANS FOR CEILING DESCRIPTIONS AND HEIGHTS.

- SPRINKLERS ARE TO BE COORDINATED WITH ALL DIFFUSERS, SPEAKERS, LIGHTING FIXTURES AND CEILING SYSTEMS. SPACING OF SPRINKLERS SHALL BE IN ACCORDANCE WITH NFPA 13 AND THE LISTING OF THE SPRINKLER.
- SLEEVE AND/OR FIRESTOP ALL PENETRATIONS THROUGH RATED WALLS, CEILINGS, AND FLOORS WITH U/L LISTED ASSEMBLIES. FIRESTOP ASSEMBLIES SHALL BE EQUAL OR EXCEED THE RATING OF THE WALL, CEILING OR FLOOR. SEE ARCHITECTURAL DRAWINGS FOR FINAL FINISHES.
- 8. PROVIDE A UPDATED ATTACHED NAME TAG TO THE RISER STATING THE REQUIRED DESIGN CRITERIA FOR THE HYDRAULICALLY-DESIGNED SYSTEM.
- 9. PROVIDE SPRINKLER GUARDS ON ALL HEADS IN ELECTRIC ROOMS, TELEPHONE ROOMS, ELEVATOR ROOMS, ELEVATOR SHAFTS AND ON ANY HEADS LESS THAN 7'-0" ABOVE THE FLOOR.
- 10. IF SYSTEM PRESSURE EXCEEDS 100 PSI, ALL HANGERS ON END HEADS IN PENDANT POSITION SHALL BE WITHIN 12" OF END OF LINE IN ACCORDANCE WITH NFPA 13.
- COORDINATE PIPING WITH ALL ELECTRICAL EQUIPMENT (PANELS, TRANSFORMERS, ETC.) PRIOR TO ANY INSTALLATION. DO NOT ROUTE ANY PIPING OVER ANY ELECTRICAL PANELS UNDER ANY CIRCUMSTANCES. ANY PIPING RUN OVER ELECTRICAL SHALL BE REROUTED AT NO ADDITIONAL COST.
- 12. SPRINKLERS IN EQUIPMENT ROOMS ARE TO BE INTERMEDIATE TEMPERATURE 200°F SPRINKLERS PER NFPA 13.



Leonard A Spears, P.E. Florida License #64985

DATE	REVISION		

ISSUE DATE: ??? ISSUE: PERMIT

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BAPTIST MEDICAL CENTER INTERSTATE 95 EXIT 335 14550 OLD ST. AUGUSTINE ROAD JACKSONVILLE, FLORIDA 32258

TIMESHARE MOB2 SUITE #2371

SHEET NAME:	
SPECIFICATIONS	
FIRE PROTECTION	

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C & A FN: 3943

Est. Project GSF:

BOMA SF:

SHEET NUMBER:

SEAL

Leonard A Spears, P.E. Florida License #64985

DATE REVISION

ISSUE DATE: ???
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TIMESHARE MOB2 SUITE #2371

PARTIAL 2ND FLOOR
NEW WORK
FIRE PROTECTION

SCALE: AS NOTED

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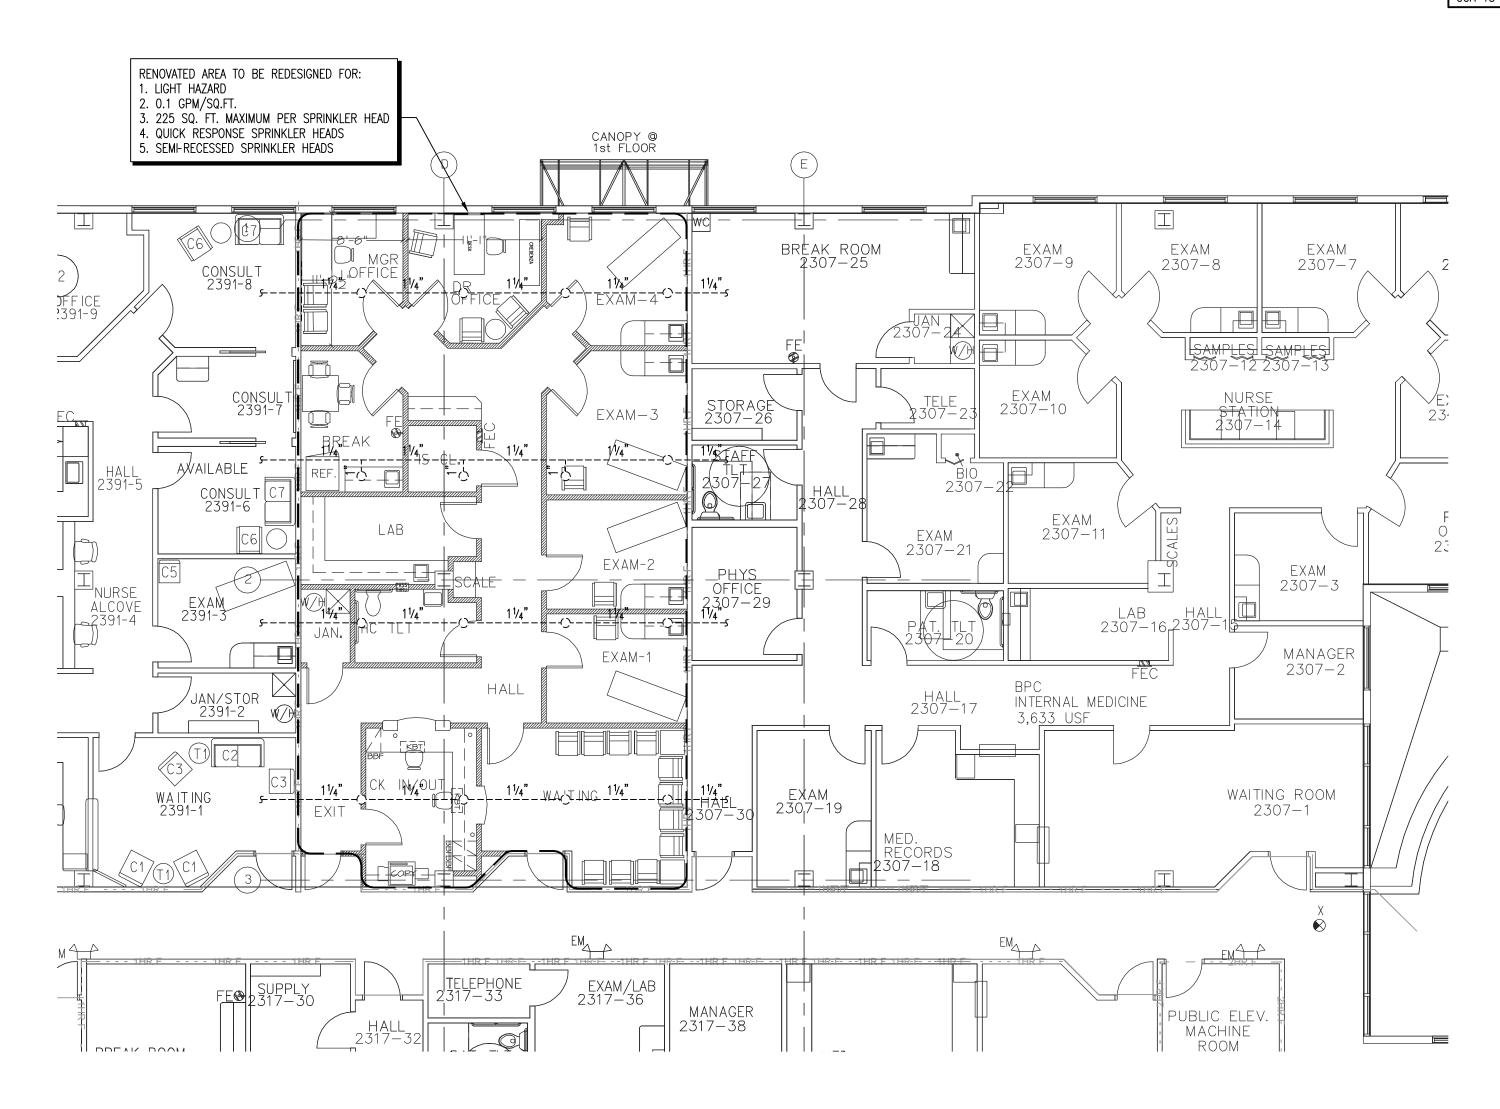
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BAPTIST MEDICAL CENTER INTERSTATE 95 EXIT 335 14550 OLD ST. AUGUSTINE ROAD JACKSONVILLE, FLORIDA 32258

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SHEET NAME: DETAILS FIRE PROTECTION

SCALE: AS NOTED

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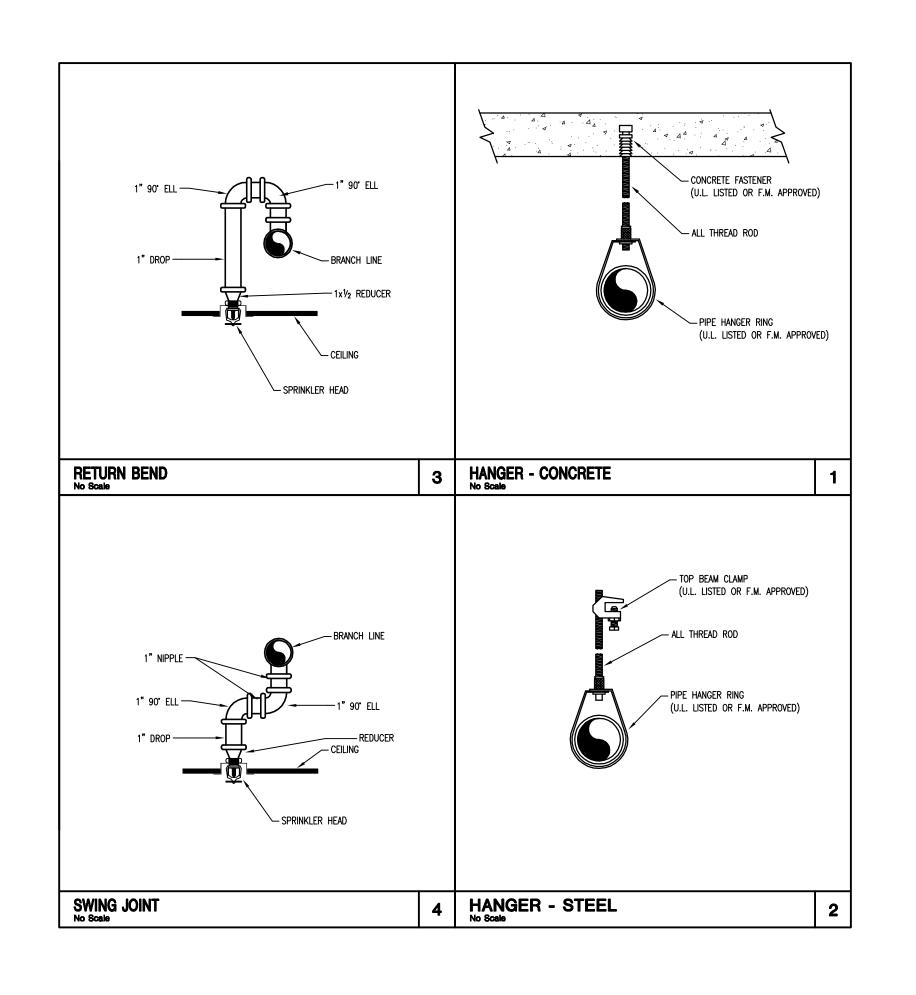
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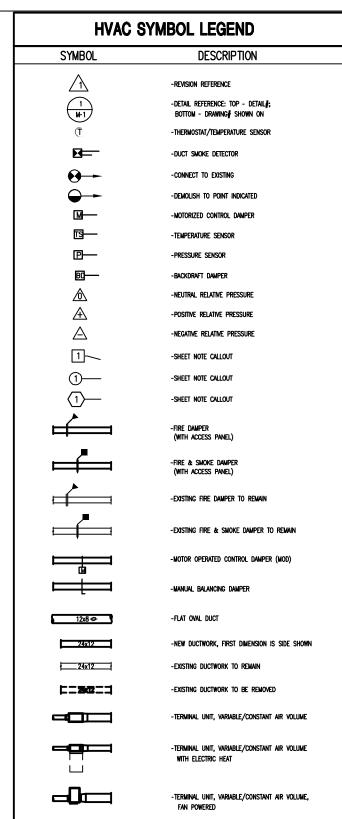
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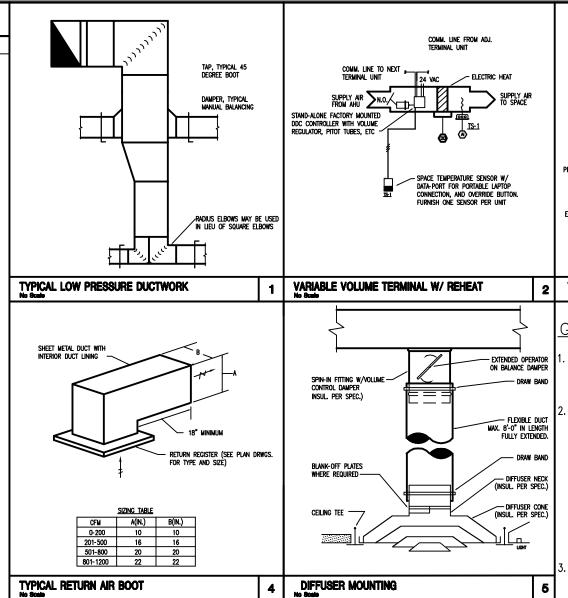
SYMBOL	DESCRIPTION	SYMBOL	DESCRIPTION
AHU	-AIR HANDLING UNIT	OA	-OUTSIDE AIR
BTU	-BRITISH THERMAL UNIT	RA	-return air
Q	-CENTER LINE	RHC	-REHEAT COIL
£	-CFM (CUBIC FEET PER MINUTE)	RPM	-revolutions per minute
CV	-CONSTANT AIR VOLUME	SA	-SUPPLY AIR
CFM	-CUBIC FEET PER MINUTE	SP	-STATIC PRESSURE
EAT	-ENTERING AIR TEMPERATURE	TSP	-TOTAL STATIC PRESSURE
ESP	-EXTERNAL STATIC PRESSURE	V/PH	-VOLTS/PHASE
EWT	-ENTERING WATER TEMPERATURE	VAV	-VARIABLE AIR VOLUME
FCU	-FAN COIL UNIT	VFD	-VARIABLE FREQUENCY DRIVE
FD	-FIRE DAMPER	ΔΡ	-CHANGE IN PRESSURE
FF	-Final filters	ΔΤ	-CHANGE IN TEMPERATURE
FLA	-FULL LOAD AMPS		
FPM	-FEET PER MINUTE		
GPM	-GALLONS PER MINUTE		
KW	-KILOWATT		
LAT	-LEAVING AIR TEMPERATURE		
LWT	-LEAVING WATER TEMPERATURE		
LD	-LINEAR DIFFUSER		
MBH	-Thousand btu³/4 per hour		
MCA	-MINIMUM CIRCUIT AMPS		
MOCP	-MAXIMUM OVER CURRENT PROTECTION		
MOD	-MOTOR OPERATED CONTROL DAMPER (MOD)	
NC	-NORMALLY CLOSED		
NO	-NORMALLY OPEN		

-TERMINAL UNIT, VARIABLE/CONSTANT AIR VOLUME

-ELECTRIC DUCT HEATER (W/PANEL CLEARANCE)

FAN POWERED, WITH ELECTRIC HEAT

-FLEXIBLE DUCT




MARK	CFM	NECK SIZE (IN)	FACE SIZE	DESCRIPTION
191/11/11	000-110	6 Ø	24x24	SUPPLY DIFFUSER
			I	
	111-240	8 Ø	24x24	BASIS OF DESIGN: TITUS TDCA-AA
Α	241-420	10 Ø	24x24	COLOR: WHITE
	421-620	12 Ø	24x24	MATERIAL: ALUMINUM
	621-800	14 Ø	24x24	OPPOSED BLADE DAMPERS: NO
	801-950	16 Ø	24x24	BACK PAN SIZE: 18X18
	000-125	6 Ø	24x24	RETURN/EXHAUST GRILLE
	126-220	8 Ø	24x24	BASIS OF DESIGN: TITUS 50F
	221-340	10 Ø	24x24	COLOR: WHITE
_	341-500	12 Ø	24x24	MATERIAL: STEEL
В	501-640	14 Ø	24x24	OPPOSED BLADE DAMPERS: NO
	641-750	16 Ø	24x24	WITH FACTORY-MANUFACTURED
	750-1600	22X22	24x24	PLENUM AND TRANSITION FROM
				DUCT RUN OUT SIZE TO NECK
				SIZE.
	000-160	6x6		SUPPLY SIDEWALL DIFFUSER
	161-250	8X6		BASIS OF DESIGN: TITUS 271FL
	251-330	12X6		COLOR: WHITE
c I	331-500	18X6		MATERIAL: EXTRUDED ALUMINUM
	501-890	18X10		OPPOSED BLADE DAMPERS: NO
	891-1450	24X12		SINGLE DEFLECTION
				3/4" SPACING
	000-160	6X6		RETURN/EXHAUST SIDEWALL GRILLI
	161-210	8X6		BASIS OF DESIGN: TITUS 56FL
	211–330	12X6		COLOR: WHITE
ъΙ	331-500	18X6		MATERIAL: EXTRUDED ALUMINUM
۱ ۲	501-780	18X10		OPPOSED BLADE DAMPERS: NO
	781–1275	24X12		O' FIXED DEFLECTION
		36X18		3/4" SPACING
	1276-2600		10.40	
	000-100	6ø	12x12	RETURN/EXHUAST GRILLE
				BASIS OF DESIGN: TITUS 50F
				COLOR: WHITE
E				MATERIAL: STEEL
- 1				OPPOSED BLADE DAMPERS: NO
				WITH FACTORY MANUFACTURED
				PLENUM AND TRANSITION FROM
				DUCT RUN OUT SIZE TO NECK
				SIZE.
	000-110	6 Ø	12x12	Supply diffuser
	000-110	6 Ø	12x12	BASIS OF DESIGN: TITUS TDCA-AA
F	000-110	6 Ø	12x12	BASIS OF DESIGN: TITUS TDCA—AA COLOR: WHITE
F	000-110	6 Ø	12x12	BASIS OF DESIGN: TITUS TDCA-AA
F	000-110	6 Ø	12x12	BASIS OF DESIGN: TITUS TDCA—AA COLOR: WHITE

	NEW TERMINAL BOX WITH ELECTRIC HEATING COIL SCHEDULE														
	PLAN SELECTION BASED ON INLET SIZE PRIMARY AIR ELECTRIC HEATING COIL														LIEATING
	ARK	MANUFACTURER	MODEL	(IN)	PRIMA	XI AIK	AIRSIDE			кw	CAPACITY	STEPS	VOLT	PHASE	HEATING CFM
141/	uut	MANOFACTORER	WIODEL	()	DESIGN CFM	MINIMUM CFM	EAT °F	LAT °F	ΔPINH ₂ O	ICAA	BTUH	BTUH SILFS		FIIASE	O W
VTU-	-3-21	ENVIRO - TEC	SDR - EH	6	225	70	55	85	0.1	2	7328	3	480	3	225
VTU-	-3-22	ENVIRO - TEC	SDR - EH	8	500	150	55	85	0.1						
VTU-	-3-23	ENVIRO - TEC	SDR - EH	8	550	165	55	85	0.1	3	8956	3	480	3	275

1. NC RATING IS AT 1" WC STATIC. MAX NC RATING SHALL BE 20.

2. VTU-3-22 SHALL BE WIRED WITH LOW VOLTAGE POWER FOR ACTUATORS AND CONTROLS ONLY.

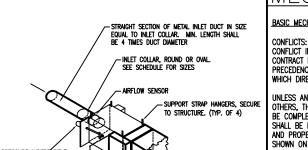

SHEET METAL DUCTWORK W/

VARIABLE VOLUME TERMINAL W/ELECTRIC HEAT

<u>SENERAL NOTES</u>

CONNECTION TO EQUIPMENT SHALL BE VERIFIED WITH MANUFACTURER'S CERTIFIED DRAWINGS. TRANSITIONS TO ALL EQUIPMENT SHALL BE VERIFIED AND PROVIDED FOR EQUIPMENT FURNISHED. DIMENSIONS SHALL BE FIELD-VERIFIED AND COORDINATED PRIOR TO PROCUREMENT OR FABRICATION. COORDINATE THE WORK WITH OTHER TRADES INVOLVED. FIELD MODIFICATIONS SUCH AS OFFSETS IN PIPING OR DUCTWORK (INCLUDING DIVIDED DUCTWORK) NEEDED DUE TO OBSTRUCTIONS OR INTERFERENCES SHALL BE PROVIDED AT NO ADDITIONAL COST. FOR PROJECTS INVOLVING RENOVATION, COORDINATE NEW WORK WITH EXISTING ELEMENTS SUCH AS THE BUILDING STRUCTURE AND ARCHITECTURAL FEATURES, SPRINKLER PIPING, LIGHTS, PLUMBING, AND ELECTRICAL CONDUIT. DUCT CONSTRUCTION SHALL BE IN ACCORDANCE WITH THE LATEST EDITION OF THE SMACNA HVAC DUCT CONSTRUCTION STANDARD. PROVIDE AIR TURNING VANES IN ALL 90 DEGREE

RECTANGULAR DUCT ELBOWS. DUCT SIZES AND ALL OPENINGS THROUGH BUILDING CONSTRUCTION SHALL SUIT EQUIPMENT FURNISHED. COORDINATE DIFFUSER, GRILLE AND REGISTER LOCATIONS WITH ARCHITECTURAL REFLECTED CEILING

PLANS AND EQUIPMENT OF ALL TRADES. LOCATE THERMOSTATS, TEMPERATURE SENSORS, HUMIDISTATS, AND HUMIDITY SENSORS AT 48" ABOVE FINISHED FLOOR UNLESS NOTED OTHERWISE. COORDINATE LOCATIONS WITH OTHER EQUIPMENT,

FURNITURE, AND DOOR SWINGS. ALL EQUIPMENT, DUCTWORK, ETC., SHALL BE SUPPORTED AS DETAILED AND/OR SPECIFIED. PROVIDE ADDITIONAL SUPPORTS AS REQUIRED TO PROVIDE A VIBRATION-FREE, RIGID INSTALLATION. ALL DUCT SIZES SHOWN ARE INSIDE CLEAR

DIMENSIONS. DAMPERS AND INSIDES OF DUCTS VISIBLE THROUGH GRILLES, REGISTERS AND DIFFUSERS SHALL BE PAINTED FLAT BLACK.

REFER TO TYPICAL DETAILS FOR INSTALLATION OF

ACCESS PANELS IN DUCTWORK AND CEILINGS SHALL OTHER WASTE MATERIALS USED IN THE INSTALLATION. 12. BE PROVIDED WHERE REQUIRED FOR OPERATION, BALANCING OR MAINTENANCE OF ALL MECHANICAL EQUIPMENT.

13. ALL DUCTWORK AND PIPING IS SHOWN SCHEMATICALLY. PROVIDE ALL TRANSITIONS, TURNING VANES, ELBOWS, FITTINGS, ETC., TO ALLOW SMOOTH FLOWS. ALL SPLIT DUCT FITTINGS SHALL TRANSITION TO FULL SIZE OF THE SUM OF BOTH BRANCHES, UPSTREAM OF SPLIT.

VERIFY FINISH WITH ARCHITECT PRIOR TO PURCHASING GRILLES, REGISTERS, DIFFUSERS, LOUVERS AND OTHER AIR DISTRIBUTION DEVICES.

PROVIDE FLEXIBLE DUCT CONNECTIONS ON ALL DUCTWORK CONNECTING TO EACH FAN, AIR HANDLING UNITS, AND FAN COIL UNITS.

PROVIDE TRANSITIONS AT DIFFUSER NECKS AS REQUIRED TO MATCH SIZES OF FLEX DUCTS TO CONNECTED

INTERRUPTIONS TO EXISTING SERVICES SHALL BE SCHEDULED FOR TIMES OTHER THAN NORMAL OPERATING HOURS (SUCH AS NIGHTS AND WEEKENDS). SUCH INTERRUPTIONS TO SERVICES SHALL NOT BE MADE WITHOUT THE PRIOR WRITTEN CONSENT OF THE OWNER'S REPRESENTATIVE AND PROPER COORDINATION WITH OTHER TRADES. PRE-WORK SHALL BE PERFORMED TO MAKE THE SHUTDOWN PERIOD AS BRIEF AS POSSIBLE.

18. ALL EQUIPMENT, DUCTWORK, ETC., TO BE REMOVED SHALL REMAIN PROPERTY OF THE OWNER OR DISPOSED OF LEGALLY, AS DIRECTED BY OWNER.

DUCTWORK, PIPING, EQUIPMENT, ETC., AND ALL FIRE WORK WITH EXISTING EQUIPMENT, INCLUDING REMOVING, RELOCATING, RATED AND FIRE/SMOKE RATED PARTITIONS, TO ALLOW FOR INSPECTIONS OF RATED WALLS.

DUCT RUNOUTS TO DIFFUSERS SHALL MATCH THE SIZE OF THE DIFFUSER NECK AT A MINIMUM. LARGER SIZES SHOWN ON DRAWINGS AND SCHEDULE OWNER'S CONTAINERS.

EXISTING AIR HANDLING UNIT SCHEDULE

REBALANCE AS SHOWN ON SCHEDULE

MECHANICAL SPECIFICATIONS

BASIC MECHANICAL REQUIREMENTS

CONFLICTS: NOTHING CONTAINED HEREIN SHALL BE CONSTRUED TO CONFLICT IN ANY WAY WITH OTHER PROVISIONS OR REQUIREMENTS OF THE CONTRACT DOCUMENTS. THE INTENT IS THAT THIS SECTION WILL TAKE PRECEDENCE. WHERE DIFFERENCES ARISE, THE ARCHITECT SHALL DECIDE WHICH DIRECTIONS OR INSTRUCTIONS TAKE PRECEDENCE.

unless an item is specifically mentioned as being provided by OTHERS, THE REQUIREMENTS OF DIVISION 15 CONTRACT DOCUMENTS SHALL BE COMPLETED. THE SYSTEMS, EQUIPMENT, DEVICES AND ACCESSORIES SHALL BE INSTALLED, FINISHED, TESTED AND ADJUSTED FOR CONTINUOUS AND PROPER OPERATION. ANY APPARATUS, MATERIAL OR DEVICE NOT SHOWN ON THE DRAWINGS BUT MENTIONED IN THESE SPECIFICATIONS, OR VICE VERSA, OR ANY INCIDENTAL ACCESSORIES NECESSARY TO MAKE THE PROJECT COMPLETE AND OPERATIONAL IN ALL RESPECTS, SHALL BE FURNISHED, DELIVERED AND INSTALLED WITHOUT ADDITIONAL EXPENSE TO THE OWNER. INCLUDE ALL MATERIALS, EQUIPMENT, SUPERVISION, OPERATION, METHODS AND LABOR FOR THE FABRICATION, INSTALLATION, START-UP AND TESTS NECESSARY FOR COMPLETE AND PROPERLY

COMPLY WITH ALL RULES, REGULATIONS, STANDARDS, CODES, ORDINANCES AND LAWS OF LOCAL, STATE AND FEDERAL GOVERNMENTS AND THE AMENDMENTS AND INTERPRETATION OF SUCH RULES, REGULATIONS, TANDARDS, CODES, ORDINANCES AND LAWS OF LOCAL, STATE AND EDERAL GOVERNMENTS BY THE AUTHORITIES HAVING LAWFUL

NFPA: COMPLY WITH THE NATIONAL FIRE CODES COMPILED BY THE NATIONAL FIRE PROTECTION ASSOCIATION

STANDARD BUILDING CODE: CONFORM IN STRICT COMPLIANCE TO THE FLORIDA BUILDING CODE-BUILDING 2007 EDITION FLORIDA BUILDING CODE - MECHANICAL 2007 AND THE AMENDMENTS TO THESE CODES WHICH ARE ENFORCED BY THE LOCAL AUTHORITY HAVING LAWFUL JURISDICTION.

DRAWINGS AND SPECIFICATIONS INTENT: THE INTENT OF THE DRAWINGS AND SPECIFICATIONS IS TO ESTABLISH MINIMUM ACCEPTABLE QUALITY STANDARDS FOR MATERIALS, EQUIPMENT AND WORKMANSHIP, AND TO PROVIDE OPERABLE MECHANICAL SYSTEMS COMPLETE IN EVERY RESPECT.

EQUIPMENT PLACEMENT: THE DRAWINGS ARE DIAGRAMMATIC, INTENDED TO SHOW GENERAL ARRANGEMENT, CAPACITY AND LOCATION OF VARIOUS COMPONENTS, EQUIPMENT AND DEVICES. EACH LOCATION SHALL BE DETERMINED BY REFERENCE TO THE GENERAL BUILDING PLANS AND BY ACTUAL MEASUREMENTS IN THE BUILDING AS BUILT. REASONABLE CHANGES IN LOCATIONS ORDERED BY THE ARCHITECT PRIOR TO THE PERFORMANCE OF THE AFFECTED WORK SHALL BE PROVIDED AT NO ADDITIONAL COST TO

DRAWING SCALE: DUE TO THE SMALL SCALE OF THE DRAWINGS, AND TO UNFORESEEN JOB CONDITIONS, ALL REQUIRED OFFSETS, TRANSITIONS AND FITTINGS MAY NOT BE SHOWN BUT SHALL BE PROVIDED AT NO ADDITIONAL

CONFLICT: IN THE EVENT OF A CONFLICT, THE ARCHITECT WILL RENDER AN INTERPRETATION IN ACCORDANCE WITH THE GENERAL CONDITIONS.

ABBREVIATIONS: ABBREVIATIONS, WHERE NOT DEFINED IN THE CONTRACT DOCUMENTS, SHALL BE INTERPRETED TO MEAN THE NORMAL CONSTRUCTION INDUSTRY TERMINOLOGY AS DETERMINED BY THE ARCHITECT. PLURAL WORDS SHALL BE INTERPRETED AS SINGULAR AND SINGULAR WORDS SHALL BE INTERPRETED AS PLURAL WHERE APPLICABLE FOR CONTEXT OF THE CONTRACT DOCUMENTS.

GENERAL: THE INSTALLATION OF MATERIALS AND EQUIPMENT SHALL BE DONE IN A NEAT, WORKMANLIKE AND TIMELY MANNER BY AN ADEQUATE NUMBER OF CRAFTSMEN KNOWLEDGEABLE OF THE REQUIREMENTS OF THE CONTRACT DOCUMENTS. THEY SHALL BE SKILLED IN THE METHODS AND CRAFTSMANSHIP NEEDED TO PRODUCE A FIRST-QUALITY INSTALLATION. PERSONNEL WHO INSTALL MATERIALS AND EQUIPMENT SHALL BE QUALIFIED TRAINING AND EXPERIENCE TO PERFORM THEIR ASSIGNED TASKS.

HOUSEKEEPING: KEEP INTERIORS OF DUCT AND PIPE SYSTEMS CLEAN AND FREE FROM DIRT, RUBBISH AND FOREION MATTER. CLOSE OPEN ENDS OF PIPING AND DUCTWORK AT ALL TIMES THROUGHOUT THE INSTALLATION.

EQUIPMENT PROTECTION: PROTECT FAN MOTORS, SWITCHES, EQUIPMENT, FIXTURES, AND OTHER ITEMS FROM DIRT, RUBBISH AND FOREIGN MATTER. DO NOT OPERATE AIR HANDLING EQUIPMENT IF THE BUILDING IS NOT CLEAN OR IF DUST CAN ENTER THE COILS OR THE FAN HOUSINGS.

EQUIPMENT CLEANING: THOROUGHLY CLEAN EQUIPMENT AND ENTIRE PIPING SYSTEMS INTERNALLY UPON COMPLETION OF INSTALLATION AND

BUILDING CLEANUP: REMOVE DEBRIS, RUBBISH, LEFTOVER MATERIALS, TOOLS AND EQUIPMENT FROM WORK AREAS AND SITE. CLEAN TUNNELS AND CLOSED OFF SPACES OF PACKING BOXES, WOOD FRAME MEMBERS AND

FILTER REPLACEMENT: PROVIDE FILTERS, WITH THE SAME EFFICIENCY RATING AS REQUIRED FOR THE FINAL INSTALLATION, FOR THE PROTECTION OF THE AIR MOVING EQUIPMENT AND DUCTWORK CONTINUOUSLY THROUGHOUT THE CONSTRUCTION PHASE. PROVIDE A NEW SET OF CLEAN FILTERS FOR THE TEST AND BALANCE OF THE AIR SIDE EQUIPMENT.

PROTECTION OF FINISHED INSTALLATION: WHERE INSTALLATION IS REQUIRED IN AREAS PREVIOUSLY FINISHED BY OTHER TRADES, PROTECT THE AREA FROM MARRING, SOILING OR OTHER DAMAGE.

CORRECTION OF WORK GENERAL: AT NO ADDITIONAL COST TO THE OWNER, RECTIFY
DISCREPANCIES BETWEEN THE ACTUAL INSTALLATION AND CONTRACT DOCUMENTS WHEN IN THE OPINION OF THE T&B AGENCY OR THE ARCHITECT THE DISCREPANCIES WILL AFFECT SYSTEM BALANCE AND PERFORMANCE.

DRIVE CHANGES: INCLUDE THE COST OF ALL PULLEY, BELT, AND DRIVE CHANGES, AS WELL AS BALANCING DAMPERS, VALVES AND FITTINGS, AND ACCESS PANELS TO ACHIEVE PROPER SYSTEM BALANCE RECOMMENDED BY THE T&B AGENCY.

COORDINATION AND ASSISTANCE GENERAL: PROVIDE ALL LABOR, EQUIPMENT, TOOLS AND MATERIAL
REQUIRED TO OPERATE THE EQUIPMENT AND SYSTEMS NECESSARY FOR THE
TESTING AND BALANCING OF THE SYSTEMS.

COORDINATION: COORDINATE THE WORK OF ALL TRADES AND EQUIPMENT SUPPLIERS TO COMPLETE THE MODIFICATIONS RECOMMENDED BY THE T&B AGENCY AND ACCEPTED BY THE ARCHITECT. CUT OR DRILL HOLES FOR THE INSERTION OF AIR MEASURING DEVICES AS DIRECTED FOR TEST PURPOSES; REPAIR TO AS-NEW CONDITION. INSERTING PLASTIC CAPS OR COVERS TO PREVENT AIR LEAKAGE. REPAIR OR REPLACE INSULATION AND RE-ESTABLISH THE INTEGRITY OF THE VAPOR RETARDANT.

I AYOUT OF EXISTING EQUIPMENT GENERAL: EXISTING EQUIPMENT, PIPING, DUCTWORK, ETC., AS INDICATED ON THE DRAWINGS HAVE, FOR THE MOST PART, BEEN PROVIDED TO THE ARCHITECT THROUGH EXISTING DRAWINGS. THE LAYOUTS SHOWN MAY NOT BE FROM AS-BUILT DRAWINGS AND MAY BE FROM PARTIAL COPIES OF ORIGINAL DESIGN DOCUMENTS NOT PRODUCED BY THE ARCHITECT. THE ARCHITECT IS NOT RESPONSIBLE FOR THE ACCURACY NOR COMPLETENESS OF THE EXISTING INSTALLATION AND ALL LAYOUTS ARE SHOWN FOR REFERENCE ONLY. IT IS TO BE UNDERSTOOD THAT UNFORESEEN CONDITIONS PROBABLY EXIST AND THAT EXISTING AND NEW WORK MAY NOT BE FIELD LOCATED EXACTLY AS SHOWN ON THE DRAWINGS. VERIFY MAINTAIN CLEARANCE OF A MINIMUM OF 6" BETWEEN EXISTING CONDITIONS IN THE FIELD AND NOTIFE THE ARCHITECT OF ANY DEVATIONS REQUIRED TO INSTALL THE WORK AS SHOWN. COORDINATE NEW PIPING, DUCTWORK, CONDUITS, WIRING, TUBING, SUPPORTS AND OTHER FOUIPMENT. THE ARCHITECT SHALL MAKE THE FINAL DECISION ON ALL

> CLEAN-UP GENERAL: DEBRIS AND RUBBISH SHALL NOT BE DISPOSED INTO THE

> PERFORMANCE VERIFICATION TEST AND BALANCE AGENCY GENERAL: PERFORMANCE VERIFICATION SHALL BE PERFORMED BY AN

CERTIFICATION: THE T&B AGENCY SHALL BE A CERTIFIED MEMBER OF THE ASSOCIATED AIR BALANCE COUNCIL (AABC) OR THE NATIONAL ENVIRONMENTAL BALANCING BUREAU (NEBB).

EXISTING EXHAUST FAN SCHEDULE | PLAN | LOCATION | AREA | TYPE | TOTAL | NEW | PREVIOUS | PRE | FINAL | SUPPLY | QA. | QA. | FILTER | FILTER | LOCATION AHU-3 MECH ROOM 3RD FLR DRAW-THRU 18000 2725 2500 YES YES EF-3 3RD FLR INLINE CENTRIFUGAL 2725 2500 REBALANCE EXHAUST FAN TO NEW FLOW



WORK INCLUDED GENERAL: THE T&B AGENCY SHALL PROVIDE ALL LABOR, SUPERVISION, PROFESSIONAL SERVICES, TOOLS, TEST EQUIPMENT AND INSTRUMENTS. (EXCEPT AS OTHERWISE INDICATED) TO PERFORM WORK OF THIS SECTION: ncluding but not limited to test and balance of all systems shown

REVIEW THE AUTOMATIC TEMPERATURE CONTROL AND AIR TERMINAL UNIT SPECIFICATIONS FOR THEIR EFFECTS ON THE TESTING AND BALANCING PROCEDURES FOR THE AIR SYSTEMS.

WHERE CONDITIONS MAY EXIST IN THE SYSTEM DESIGN OR WHERE CONDITIONS MAY EXIST IN THE STSTEM DESIGN OF CONSTRUCTION WHICH MAY ADVERSELY AFFECT SYSTEM PERFORMANCE, IDENTIFY THE CONDITIONS AND SUBMIT RECOMMENDED CORRECTIONS IN WRITING FOR CONSIDERATION BY THE ARCHITECT.

PERFORM A COMPLETE AIR TEST AND BALANCE OF ALL HEATING, VENTILATING, AIR CONDITIONING AND EXHAUST AIR SYSTEMS SHOWN AND DESCRIBED ON THE CONTRACT DOCUMENTS WITHIN +/- 10%. PROVIDE THREE FINAL COPIES OF REPORT TO ARCHITECT.

<u>DUCTWORK</u>

APPLICABLE STANDARDS SMACNA: USE MATERIAL, WEIGHT, THICKNESS, GAUGE, REINFORCING, SEAMS INSTALLATION METHODS AS OUTLINED IN THE SHEET METAL AND AIR CONDITIONING CONTRACTORS NATIONAL ASSOCIATION, INC., HVAC DUCT CONSTRUCTION STANDARDS, METAL & FLEXIBLE, FIRST EDITION, 1985.
MANUFACTURED ROUND OR OVAL DUCTWORK SHALL COMPLY WITH THE MANUFACTURER'S PUBLISHED RECOMMENDATIONS AND INSTALLATION

BALANCING DEVICES: IN ORDER TO MAINTAIN CLARITY OF THE DRAWINGS, NOT ALL REQUIRED DUCT BALANCING DAMPERS ARE INDICATED. HOWEVER PROVIDE EACH DUCT BRANCH AND EACH DUCT TAKEOFF WITH A BALANCING DAMPER TO ASSURE CORRECT BALANCE AND QUIET DISTRIBUTION OF INDICATED AIR QUANTITIES.

SUPPLY, RETURN, INTAKE, EXHAUST AND RELIEF DUCTWORK
MINIMUM REQUIREMENTS: UNLESS OTHERWISE INDICATED ALL DUCTWORK
SHALL COMPLY WITH THE FOLLOWING MINIMUM PRESSURE REQUIREMENTS:

3 INCH W.G. PRESSURE: FROM THE SUPPLY FAN DISCHARGE TO A TERMINAL UNIT OR ZONE 2 INCH W.G. PRESSURE:

FROM THE SUPPLY FAN DISCHARGE TO A ROOM SUPPLY AIR

From the return air inlet device to the inlet of the return fan or air handling fan return connection. 1 INCH W.G. PRESSURE:

FROM THE DISCHARGE SIDE OF A TERMINAL UNIT TO THE ROOM SUPPLY AIR DEVICE.

from the room exhaust device to the inlet of the roof

ALL SUPPLY, RETURN AND OUTSIDE AIR DUCTS SHALL BE EXTERNALLY INSULATED EXTENDING FROM SUPPLY FAN DISCHARGE, THROUGHOUT SYSTEM, TO ALL OUTLETS.

TOILET EXHAUST, GENERAL EXHAUST: DUCTWORK SHALL NOT HAVE INTERNAL INSULATION, AND DOES NOT HAVE TO BE EXTERNALLY INSULATED

TRANSITION ANGLES SHALL NOT EXCEED 30 DEGREES AT INLET CONNECTIONS TO COILS OR OTHER EQUIPMENT, NOR 15 DEGREES AT OUTLET CONNECTIONS.

THERMAL INSULATION

PERFORMANCE DATA

PROVIDE THERMAL PERFORMANCE, DENSITY AND VAPOR PERMEANCE FOR EACH TYPE OF INSULATION, FINISH, COVER, FACING OR JACKET SPECIFIED IN THIS DOCUMENT

UNLESS OTHERWISE STATED, INSULATION TYPES AND THICKNESSES SPECIFIED ARE BASED ON INSULATING MATERIALS HAVING A "K" VALUE (BTU PER HOUR PER SQUARE FOOT PER DEGREE TEMPERATURE DIFFERENCE) PER INCH OF THICKNESS AS INDICATED.

VAPOR PERMEANCE IS BASED ON VAPOR RETARDANT MATERIALS HAVING WATER VAPOR TRANSMISSION RATES IN PERMS (GRAINS OF VAPOR PER HOUR PER SQUARE FOOT PER INCH OF MERCURY VAPOR PRESSURE DIFFERENTIAL).

ALTERNATE MATERIALS SHALL BE APPROVED ON THE BASIS OF THICKNESSES PROVIDING EQUIVALENT HEAT TRANSFER OR VAPOR TRANSMISSION RATES.

NFPA: ALL MATERIALS AND ADHESIVES USED SHALL CONFORM TO THE REQUIREMENTS OF NFPA 90A, 1999 REVISION, AS TO FLAME SPREAD AND SMOKE DEVELOPED RATINGS THROUGHOUT THEIR OPERATING TEMPERATURE RANGE. ALL INSULATION, JACKETS, FACINGS AND ADHESIVES USED TO ADHERE THE JACKET OF FACING TO THE INSULATION, INCLUDING FITTINGS AND BUTT STRIPS, SHALL HAVE A NON-COMBUSTIBLE FIRE AND SMOKE HAZARD RATING AND LABEL AS TESTED BY ASTM E-84, NFPA 255, 2000 REVISION AND UL-723 NOT EXCEEDING FLAME SPREAD VALUE OF 25 AND SMOKE DEVELOPED/FUEL CONTRIBUTED VALUE OF 50. ACCESSORIES SUCH AS MASTICS, CEMENTS, TAPES AND CLOTH FOR FITTINGS SHALL HAVE THE SAME RATINGS.

FLORIDA BUILDING CODE: INSULATION THERMAL CONDUCTANCE VALUES AND INSULATION THICKNESS SHALL COMPLY WITH THE FLORIDA BUILDING CODE MECHANICAL 2007 EDITION.

INSULATION FOR DUCT SYSTEMS

GENERAL: AIR HANDLING UNIT CASINGS DOWNSTREAM OF COOLING COILS SHALL BE INSULATED. INSULATE SUPPLY AND RETURN AIR DUCTS FOR HEATING AND AIR CONDITIONING SYSTEMS FROM SUPPLY FAN DISCHARGE TO ROOM OUTLETS ON ALL SYSTEMS. OUTSIDE AIR DUCTS SHALL BE EXTERNALLY INSULATED, EXCEPT WHERE LOCATED IN MECHANICAL EQUIPMENT ROOMS.

INSULATE WITH A MINIMUM OF 2 INCH THICK FIBERGLASS BLANKET WRAP APPLIED OVER CLEAN, DRY SHEET METAL DUCTWORK INSTALLED TO ALLOW MAXIMUM FULLNESS AT CORNERS (AVOID EXCESSIVE COMPRESSION). ADHERE DUCT INSULATION TO METAL AND PROVIDE CONTINUITY OF VAPOR RETARDANT IN ACCORDANCE WITH THE MANUFACTURER'S RECOMMENDATIONS. WHERE DUCT WIDTH EXCEEDS 24 INCHES. THE INSULATION SHALL BE ADDITIONALLY SECURED TO HE BOTTOM OF THE DUCT USING MECHANICAL FASTENERS SPACED 1 FOOT ON CENTER TO PREVENT SAGGING OF THE INSULATION.

DUCTWORK INSULATION SHALL BE INORGANIC FIBROUS GLASS, FLEXIBLE BLANKET OF GLASS FIBER FACTORY LAMINATED TO A REINFORCED FOIL KRAFT (FRK) VAPOR RETARDANT WITH A MINIMUM 2 INCH TAPING AND STAPLING FLANGE ON ONE EDGE. DEGREES F. THERMAL CONDUCTIVITY OF 0.31 AT 75 DEGREES F. MINIMUM DENSITY OF 1-1/2 PCF.

<u>FIRE DAMPERS</u> GENERAL:

FIRE DAMPERS SHALL COMPLY WITH UNDERWRITERS LABORATORIES (UL) STANDARD 555 AND BEAR THE UL TEST LABEL WITH A 1-1/2 HOUR FIRE PROTECTION RATING FOR PENETRATIONS IN 1-HOUR AND 2-HOUR RATED PARTITIONS, AND A 3-HOUR FIRE PROTECTION RATING FOR PENETRATIONS IN 3-HOUR RATED PARTITIONS. DAMPERS SHALL BE TESTED UNDER DYNAMIC LOAD.

DAMPERS SHALL BE SELECTED SO THAT THE FREE AIR SPACE IS NOT LESS THAN THE CONNECTED DUCT FREE AREA.

	HVAC DRAWING INDEX	
SHEET	DESCRIPTION	ISSUED
M001	HVAC LEGEND, GENERAL NOTES, SHEET INDEX, DETAILS & SCHEDULES	Yes
M101	HVAC DEMOLITION AND NEW WORK FLOOR PLAN	Yes

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> Leonard A Spears, P.E. Florida License #64985

DATE REVISION

ISSUE DATE: ??? ISSUE: PERMIT

DRAWN BY: TLC CHECKED BY: TLC



SOUTH

BAPTIST MEDICAL CENTER INTERSTATE 95 EXIT 335 14550 OLD ST. AUGUSTINE ROAD JACKSONVILLE, FLORIDA 32258

TIMESHARE MOB2 SUITE #2371

SHEET NAME: HVAC LEGEND, DETAIL, GENERAL NOTES, SHEET INDEX, AND

SCALE: AS NOTED

LOG NO. T:\Baptist Health...\Drawings\

C & A FN: 3943

Est. Project GSF:

BOMA SF:

SHEET NUMBER:

1 of 2

1650 Prudential Drive Suite 200 Jacksonville, Florida 32207 Phone: 904-306-9111 Fax: 904-306-9117

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DATE REVISION

ISSUE DATE: ??? ISSUE: PERMIT

SEAL

DRAWN BY: JL CHECKED BY: LAS



SOUTH

BAPTIST MEDICAL CENTER INTERSTATE 95 EXIT 335 14550 OLD ST. AUGUSTINE ROAD JACKSONVILLE, FLORIDA 32258

TIMESHARE MOB2 SUITE #2371

SHEET NAME:

HVAC NEW WORKING PLANS

SCALE: AS NOTED

LOG NO. T:\Baptist Health...\Drawings\


C & A FN: 3943

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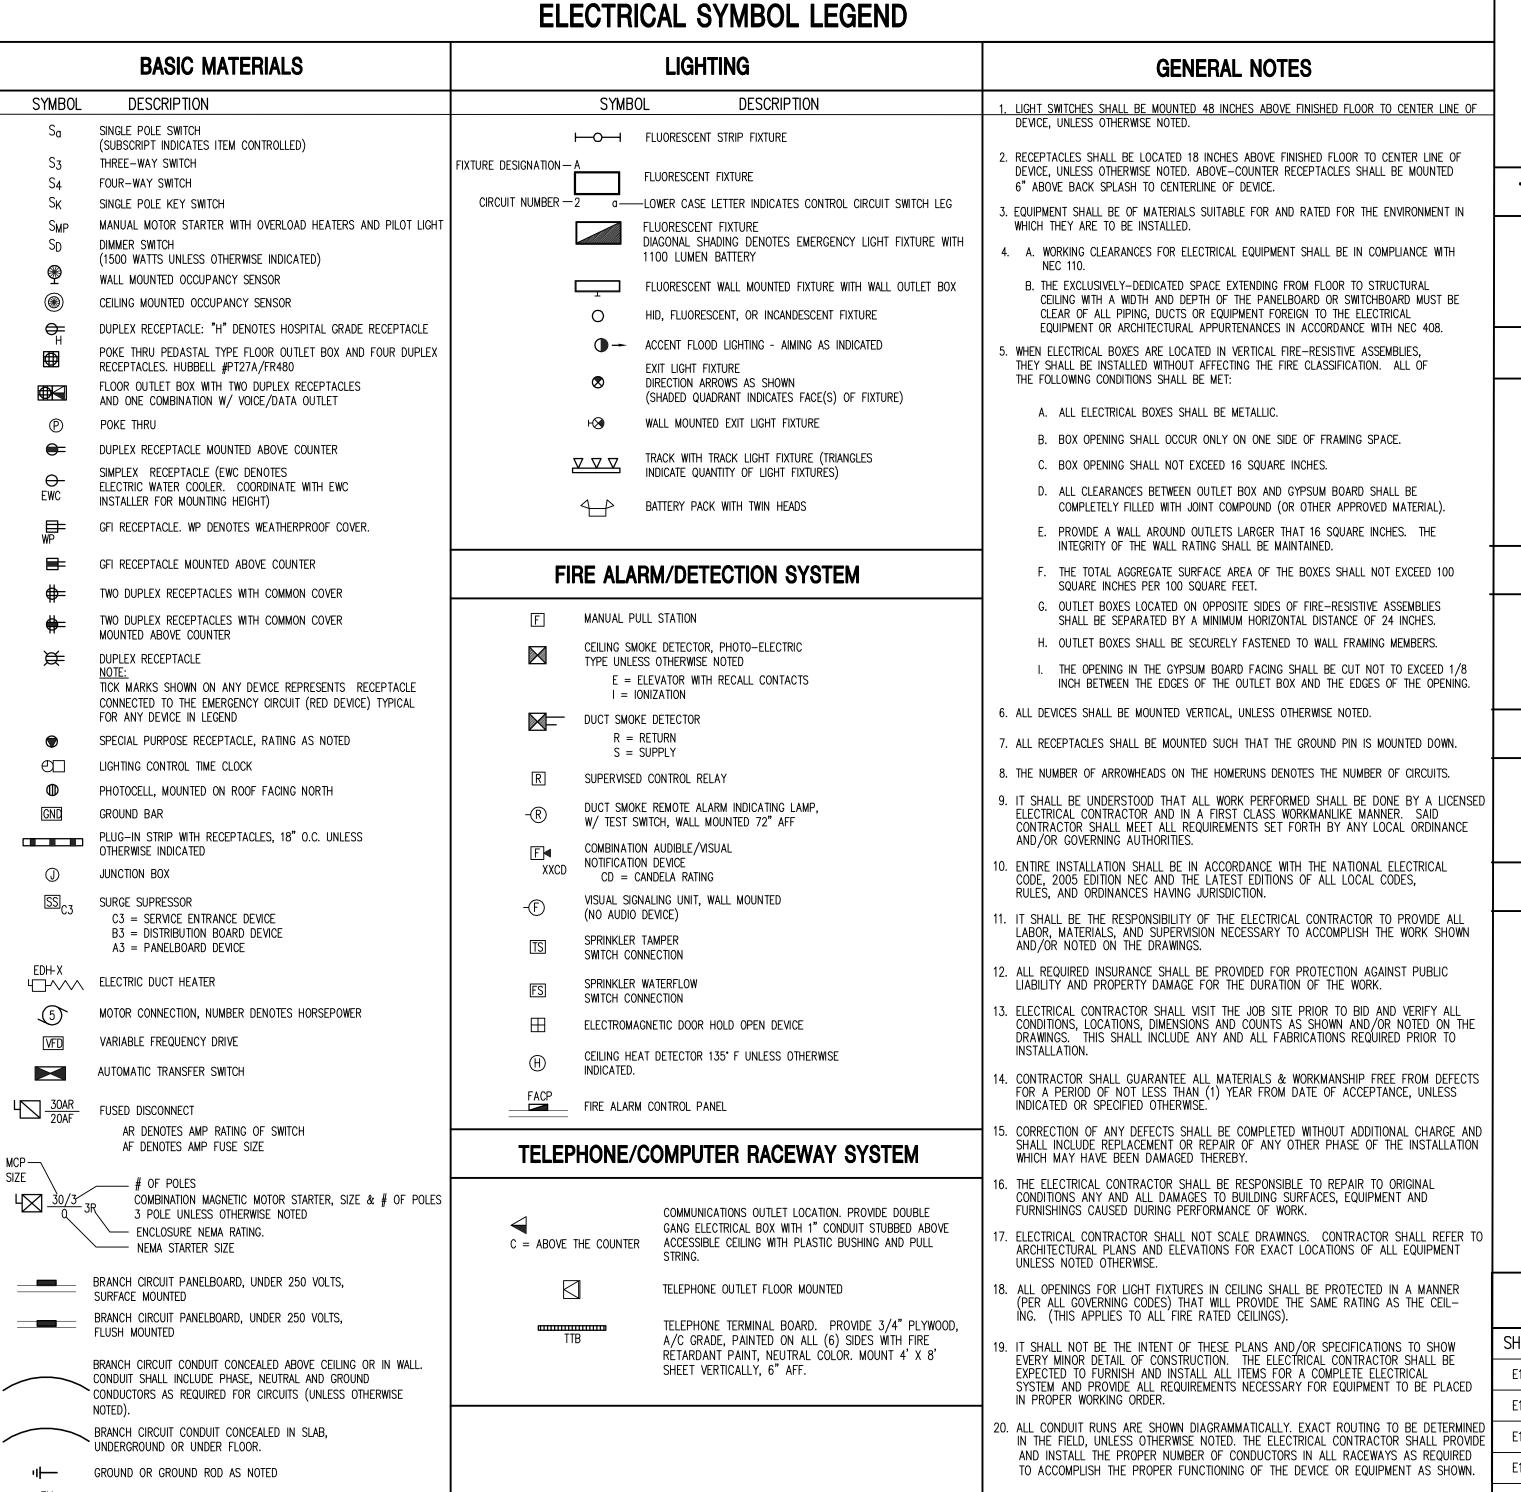
M1.1

2 **of** 2



HVAC FLOOR PLAN

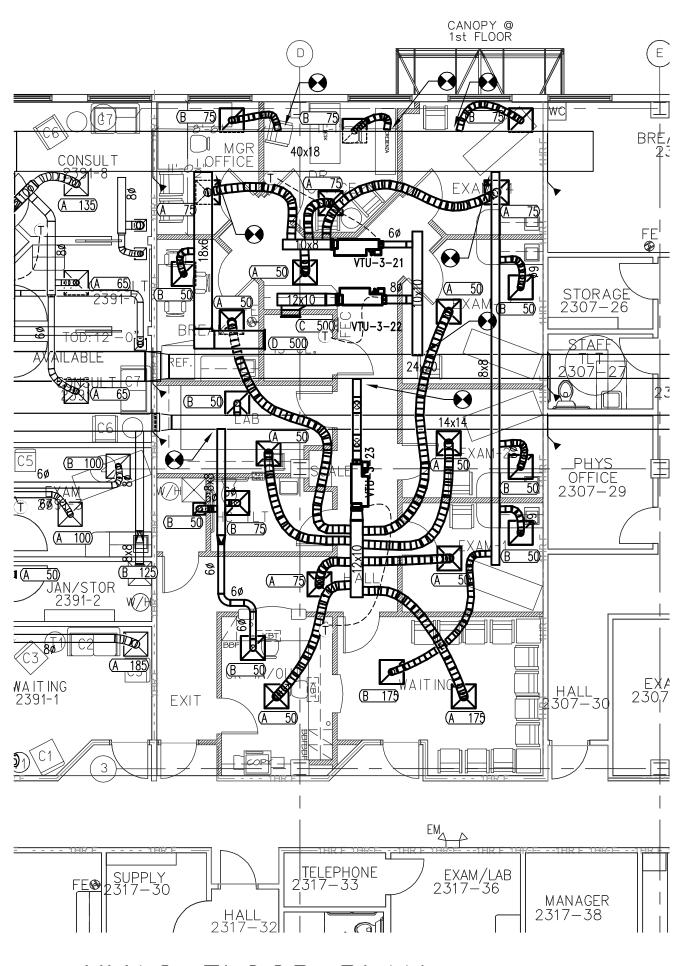SCALE: 1/8" = 1'-0"





1650 Prudential Drive Suite 200 Jacksonville, Florida 32207 Phone: 904-306-9111 Fax: 904-306-9117 ENGINEERING FOR ARCHITECTURE WWW.tlc-engineers.com © Copyright 2011 TLC Engineering for Architecture, Inc. TLC NO: 811114

TELEVISION RACEWAY DISTRIBUTION SYSTEM

TELEVISION SIGNAL WALL OUTLET

DOORBELL SYSTEM

DOOR PUSHBUTTON STATION WP = WEATHERPROOF

DOORBELL CHIME (SELF CONTAINED)

DOORBELL SYSTEM CONDUIT AND WIRING

ISSUE DATE: ??? ISSUE: PERMIT

DATE REVISION

SEAL

DRAWN BY: FAW CHECKED BY: MAGI

PAGING SYSTEM & BACKGROUND MUSIC

DESCRIPTION SYMBOL

LOUDSPEAKER / TRANSFORMER / BAFFLE / SUPPORT TRUSS. (CEILING MOUNTED) W = WALL MOUNTEDVOLUME CONTROL

DOOR CONTROL SYSTEM

(M)MOTION DETECTOR 360°

CR CARD READER

K DIGITAL KEYPAD

BALANCED MAGNETIC DOOR CONTACT **BAPTIST** MEDICAL CENTER

Michael A. Giordano, P.E.

Florida License #67555

SOUTH

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TIMESHARE MOB2 SUITE #2371

SHEET NAME: ELECTRICAL SYMBOL LEGEND NOTES & INDEX

ELECTRICAL DRAWING INDEX

SHEET	DESCRIPTION	ISSUED
E1.0	ELECTRICAL LEGEND, NOTES & INDEX	Yes
E1.1	ELECTRICAL SPECIFICATIONS	Yes
E1.2	POWER RISER DIAGRAM	Yes
E1.3	ELECTRICAL PANEL SCHEDULES	Yes
E2.1	PARTIAL 4TH FLOOR PLAN — POWER & DEMOLITION	Yes
E2.2	PARTIAL 4TH FLOOR PLAN — LIGHTING	Yes
E3.1	ELECTRICAL DETAILS	Yes

21. CONTRACTOR SHALL UPDATE ALL EXISTING PANEL DIRECTORIES TO REFLECT EXISTING

22. THE CONTRACTOR SHALL OBTAIN A FIRE ALARM PERMIT PRIOR TO INSTALLING OR

MODIFYING THE BUILDING FIRE ALARM SYSTEM.

CONDITIONS. TRACE CIRCUITS AS REQUIRED TO PROVIDE ACCURATE PANEL INFORMATION.

SCALE: AS NOTED

LOG NO. T:\Baptist Health...\Drawings\

C & A FN: 3943

Est. Project GSF:

BOMA SF:

SHEET NUMBER:

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ELECTRICAL SPECIFICATIONS

GENERAL:

CODES, PERMITS AND INSPECTIONS:

ALL WORK AND EQUIPMENT UNDER THIS DIVISION SHALL BE IN STRICT COMPLIANCE WITH THE CODES, STANDARDS AND PRACTICES LISTED HEREIN, AND THEIR RESPECTIVE DATES ARE FURNISHED AS THE MINIMUM LATEST REQUIREMENTS.

- 1. State of Florida.
- Duval County.
 City of Florida.
- 4. Life Safety Code NFPA 101 (2006)
- 5. National Fire Protection Association (NFPA).
- 6. American National Standards Institute (ANSI)
- 7. National Electrical Code NFPA 70 (2005).
- 8. National Fire Protection Association 72 (2002).
- 9. Building Code: Florida Building Code (2007).

THE INSTALLATION SHALL COMPLY WITH ALL LOCAL LAWS AND ORDINANCES APPLICABLE TO ELECTRICAL INSTALLATIONS, AND WITH THE REGULATIONS OF THE NFPA WHERE SUCH REGULATIONS DO NOT CONFLICT WITH THOSE LAWS. OBTAIN ALL PERMITS REQUIRED.

MANUFACTURERS DRAWINGS AND DATA:

SUBMIT TO THE ARCHITECT FOR APPROVAL FIVE (5) COPIES OF THE COMPLETE LIST OF ALL ELECTRICAL MATERIALS WHICH ARE PROPOSED TO BE FURNISHED FOR THIS PROJECT. AS A MINIMUM THE SUBMITTAL SHALL INCLUDE PANELBOARDS, A.I.C. OF BREAKERS INSTALLED, AND LIGHT FIXTURES

STANDARD OF MATERIALS AND WORKMANSHIP:

ALL MATERIALS, EQUIPMENT AND APPARATUS COVERED BY THIS SPECIFICATION SHALL BE NEW, OF CURRENT MANUFACTURE AND SHALL BEAR THE SEAL OF APPROVAL OF THE UNDERWRITERS LABORATORIES. ALL WORK SHALL BE EXECUTED IN A WORKMANLIKE MANNER AND SHALL PRESENT A NEAT AND MECHANICAL APPEARANCE WHEN COMPLETED.

STORAGE OF MATERIALS:

THE CONTRACTOR SHALL PROVIDE SUITABLE STORAGE FACILITIES FOR ALL MATERIAL FURNISHED BY HIM UNDER THIS CONTRACT. ALL ITEMS TO BE INSTALLED MUST BE FREE OF RUST AND DIRT.

IDENTIFICATION:

EQUIPMENT:

EQUIPMENT IDENTIFICATION SHALL BE MADE USING ENGRAVED LAMINATED PHENOLIC OR MICARTA PLATES (INDENTED TAPE LABELS WILL NOT BE PERMITTED). CHARACTERS SHALL BE WHITE ON A BLACK BACKGROUND AND 1/4" HIGH MINIMUM. PLATES SHALL BE SECURED TO THE PANELS BY MEANS OF SCREWS OR METAL PRESSURE PINS. CEMENT, BY ITSELF, WILL NOT ACCEPTABLE. ALL NAMEPLATES SHALL BE MOUNTED ON THE OUTSIDE SURFACE OF THE PIECE OF EQUIPMENT. INDIVIDUALLY ENCLOSED SAFETY SWITCHES, CIRCUIT BREAKERS, AND MOTOR STARTERS, PULL BOXES, CONTROL CABINETS AND OTHER SUCH ITEMS SHALL BE IDENTIFIED INDICATING LOAD, ELECTRICAL CHARACTERISTICS, AND SOURCE.

JUNCTION BOX IDENTIFICATION:

EACH JUNCTION BOX COVER SHALL BE LABELED WITH A PERMANENT "MAGIC" MARKER OR OTHER MEANS TO IDENTIFY THE CIRCUITS WITHIN. FOR EXAMPLE, A JUNCTION BOX CONTAINING LIGHTING CIRCUITS 21, 23, 25 FROM PANEL L2A WOULD BE LABELED "L2A-21,23,25". TELEPHONE JUNCTION BOXES SHALL BE LABELED "T". FIRE ALARM AND OTHER SYSTEM JUNCTION BOXES SHALL BE LABELED ACCORDINGLY. FIREPROOFING:

ALL CONDUIT AND BOXES PASSING THROUGH OR INSTALLED WITHIN FIRE WALLS AND SMOKE WALLS SHALL BE INSTALLED SO AS TO MAINTAIN THE INTEGRITY OF THE WALL THROUGH WHICH IT PASSES. BOXES TO BE INSTALLED WITH 1/8" OF WALL SURFACE.

TESTING:

AT THE COMPLETION OF THE WORK, A THOROUGH TEST SHALL BE MADE IN THE PRESENCE OF THE ARCHITECT OR HIS REPRESENTATIVE, AND THE ENTIRE SYSTEM SHALL BE SHOWN TO BE IN PERFECT WORKING CONDITION AS INTENDED BY THESE SPECIFICATIONS.

GUARANTEE:

THE CONTRACTOR SHALL LEAVE THE ENTIRE ELECTRICAL SYSTEM INSTALLED BY HIM UNDER THIS CONTRACT IN PROPER WORKING ORDER AND SHALL REPLACE, WITHOUT ADDITIONAL CHARGE, ALL WORK OR MATERIAL WHICH MAY DEVELOP DEFECTS, ORDINARY WEAR AND TEAR OR DAMAGE RESULTING FROM IMPROPER HANDLING EXCEPTED, WITHIN A PERIOD OF ONE YEAR FROM THE DATE OF FINAL TESTING AND ACCEPTANCE BY THE ARCHITECT. BALLASTS SHALL BE INCLUDED BUT LAMPS SHALL BE EXCLUDED.

CONDUIT AND FITTINGS:

HCFC CABLE TO BE RUN TO ALL CIRCUITS WITH HOSPITAL GRADE RECEPTACLES. MC CABLE TO BE RUN TO ALL OTHER BRANCH CIRCUITS.

FITTINGS FOR ELECTRICAL METALLIC TUBING SHALL BE STEEL SET SCREW OR COMPRESSION TYPE. DIE CAST FITTINGS OR CONNECTORS WILL NOT BE ACCEPTABLE. EMT CONNECTORS TO BE SIMILAR TO T&B "INSULINE" WITH COMPLETELY INSULATED THROATS. (FIELD APPLIED INSULATED THROATS ARE NOT ACCEPTABLE).

CONDUITS BUSHINGS SHALL BE METALLIC WITH INSULATED THROATS. INSULATING GROUNDING TYPE BUSHINGS SHALL BE PROVIDED WHERE REQUIRED UNDER 'GROUNDING'.

CONDUITS SHOWN ROUTED OVERHEAD MAY NOT BE INSTALLED IN OR BELOW SLABS OR IN WALLS.

NOT MORE THAN THREE CIRCUITS MAY BE INSTALLED IN ANY ONE CONDUIT UNLESS OTHERWISE INDICATED.

ALL CONDUITS SHALL BE CONCEALED UNLESS OTHERWISE NOTED ON THE DRAWINGS. EXPOSED CONDUIT WILL BE PERMITTED ONLY AS SHOWN ON THE DRAWINGS. EXPOSED CONDUIT SHALL BE RUN PARALLEL WITH OR AT RIGHT ANGLES TO THE BUILDING WALLS. ALL EMPTY CONDUITS SHALL BE PROVIDED WITH A PLASTIC OR NYLON FISH WIRE.

EXPOSED CONNECTIONS TO MOTORS AND EQUIPMENT FROM OVERHEAD CONDUITS SHALL CONSIST OF VERTICAL CONDUIT (MINIMUM SIZE 1") FROM TYPE "LL" OR "LR" UNILET TO FLOOR FLANGE. CONNECTION TO EQUIPMENT SHALL BE WITH FLEXIBLE METAL CONDUIT FROM TYPE FDT BOXES LOCATED IN THE VERTICAL CONDUIT.

FLEXIBLE CONDUIT IN ALL AREAS OTHER THAN CEILING PLENUM SUBJECT TO MOISTURE SHALL BE LIQUID—TIGHT FLEXIBLE CONDUIT. ALL ELECTRICAL CONNECTIONS TO VIBRATION ISOLATED EQUIPMENT SHALL BE MADE WITH FLEXIBLE CONDUIT. ALL CONDUITS ENTERING THE BUILDING SHALL BE SUITABLY SEALED TO PREVENT THE ENTRANCE OF MOISTURE. ANY WIRING IN A FINISHED AREA WHICH CANNOT BE CONCEALED IN CONDUIT SHALL BE INSTALLED IN A SURFACE METAL RACEWAY SYSTEM AS MANUFACTURED BY WREMOLD OR EQUAL. UTILIZATION OF SURFACE METAL RACEWAY, IF NOT INDICATED AS SUCH ON THE PLANS, WILL BE ACCOMPLISHED ONLY WITH THE WRITTEN APPROVAL OF THE ARCHITECT.

WHERE FLEX CONDUIT IS USED FROM JUNCTION BOX TO LIGHT FIXTURE IT SHALL BE SUPPORTED SUCH THAT IT DOES NOT TOUCH CEILING TILES OR INTERFERE WITH THEIR PLACEMENT. FLEXIBLE CONNECTIONS TO LIGHT FIXTURES SHALL BE AT LEAST 4 FEET BUT NOT MORE THAN 6 FEET IN LENGTH PER N.E.C. 410–67(c) RACEWAYS CONCEALED IN GROUND OUTSIDE BUILDING SHALL BE A MINIMUM OF 2 FEET BELOW GRADE.

CONDUCTORS:

ALL CONDUCTORS SHALL BE COPPER OF NOT LESS THAN NINETY-EIGHT PERCENT (98%) CONDUCTIVITY, WITH NEC TYPE THHN/THWN, 600 VOLT INSULATION. CONDUCTORS NO. 12 THROUGH NO. 10 MAY BE SOLID OR STRANDED AND NO. 8 AND LARGER SHALL BE STRANDED. NO CONDUCTORS SMALLER THAN NO. 12 SHALL BE USED EXCEPT AS OTHERWISE NOTED. CONTROL CONDUCTORS SHALL BE NO. 14.

WIRING:

NEUTRAL WIRES SHALL BE PIGTAILED TO RECEPTACLES SO THAT RECEPTACLE CAN BE REMOVED FOR REPLACEMENT WITHOUT THE NEUTRAL CONNECTION TO OTHER RECEPTACLES ON THE CIRCUIT BEING DISCONNECTED. WHEN STRANDED WIRE IS USED FOR RECEPTACLE AND LIGHTING CIRCUIT, CONNECTIONS TO THE DEVICES SHALL BE MADE USING VINYL INSULATED "STAKON" CONNECTOR TERMINALS.

CABLE AND WIRE SPLICES:

GENERAL:

THE MATERIALS SHALL BE COMPATIBLE WITH THE CONDUCTORS, INSULATIONS AND PROTECTIVE JACKETS OF THE RESPECTIVE CABLES AND MIDES

ALUMINUM AND ALUMINUM ALLOY FITTINGS WILL NOT BE ACCEPTED.

FOR CONDUCTOR SIZED NO. 6 AWG OR LARGER: SPLICES IN CONDUCTORS SHALL BE MADE WITH INDENTER, CRIMP CONNECTORS AND COMPRESSION TOOLS OR WITH BOLTED CLAMP TYPE CONNECTORS TO INSURE A SATISFACTORY MECHANICAL AND ELECTRICAL JOINT.

JUNCTION BOXES:

ALL JUNCTION BOXES AND PULL BOXES SHALL BE SIZED PER N.E.C. REQUIREMENTS AND BE OF THE PROPER NEMA CLASSIFICATION FOR THE LOCATIONS WHERE THEY ARE INSTALLED. WHERE BOXES OCCUR ABOVE OTHER THAN LIFT-OUT CEILINGS, ACCESS PANELS MUST BE PROVIDED.

UTLET BOXES:

SWITCH AND RECEPTACLE OUTLET BOXES SHALL BE FOUR INCH (4")
SQUARE OR FOUR AND ELEVEN SIXTEENTHS INCH (4-11/16") A MINIMUM
OF 1-1/2" DEEP WITH SWITCH RING AS REQUIRE OR GANG BOXES A
MINIMUM OF 2" DEEP WHEN MORE THAN TWO DEVICES MOUNT UNDER A

WALL TELEPHONE OUTLETS SHALL BE FOUR INCH (4") SQUARE BOXES WITH STANDARD SWITCH COVERS AND TELEPHONE COVER PLATES.

LOCATION OF OUTLETS:

THE APPROXIMATE LOCATIONS OF OUTLETS, ETC. ARE SHOWN ON THE DRAWINGS. THE EXACT LOCATIONS SHALL BE DETERMINED AT THE BUILDING. IT IS THE RESPONSIBILITY OF THE CONTRACTOR TO NOTE THE LOCATIONS AND HEIGHTS OF CABINETS, ETC. BEFORE THE INSTALLATION OF OUTLETS.

WALL SWITCHES:

ALL SWITCHES SHALL BE FLUSH ENCLOSED TYPE, SPECIFICATION GRADE, RATED AT 20 AMPERES, 120/277 VOLTS, ALTERNATING CURRENT ONLY, QUIET OPERATION, AND SHALL BE MANUFACTURED BY HUBBELL. COLOR OF ALL DEVICES SHALL BE IVORY.

MOTOR SWITCHES WITH INHERENT THERMAL OVERLOAD PROTECTION SHALL BE SQUARE D, TYPE F FOR FLUSH OR SURFACE MOUNTING AS REQUIRED BY THE LOCATION OF THE UNIT. UNITS SHALL BE FURNISHED WITH PILOT LIGHTS AS INDICATED.

RECEPTACLES:

RECEPTACLES SHALL BE FURNISHED AND INSTALLED WHERE SHOWN ON THE DRAWINGS AND SHALL CONFORM TO THE FOLLOWING REQUIREMENTS:

GROUNDING TYPE DUPLEX RECEPTACLE, RATED 20 AMPERES, 125 VOLTS, 2 WIRE, 3 POLE WITH GROUNDED SHUNT (YOKE PERMANENTLY GROUNDED TO THIRD CLIP) SHALL BE MANUFACTURED BY HUBBELL.

OTHER RECEPTACLES LISTED ON THE DRAWINGS SHALL BE SPECIFICATION GRADE RECEPTACLES. ALL RECEPTACLES SHALL BE IVORY IN COLOR.

DEVICES PLATES:

ALL PLATES FOR SWITCH, RECEPTACLES AND TELEPHONE OUTLETS LOCATED IN FINISHED WALLS SHALL BE SMOOTH THERMOPLASTIC. COLOR TO MATCH DEVICE. ALL PLATES FOR OUTLETS LOCATED ON UNFINISHED WALL OR ON CONDULET TYPE FITTINGS SHALL BE ZINC COATED SHEET METAL WITH ROUNDED OR BEVELED EDGES.

SAFETY SWITCHES:

SAFETY SWITCHES SHALL BE "HD" (HEAVY DUTY) UNLESS NOTED OTHERWISE, FUSED OR NON-FUSIBLE AS INDICATED WITH NUMBER OF POLES AS SHOWN OR REQUIRED. SAFETY SWITCHES FOR EQUIPMENT MAY BE NON-FUSED ONLY IF EQUIPMENT IS UL TESTED WITH CIRCUIT BREAKER PROTECTION. DISCONNECT SWITCHES SHALL BE PROVIDED FOR ALL MOTORS. ALL SAFETY SWITCHES SHALL BE MANUFACTURED BY GE.

<u>GROUNDING:</u>

GENERAL:

NON-METALLIC CONDUITS OR DUCTS SHALL CONTAIN GROUNDING CONDUCTOR UNLESS OTHERWISE SPECIFIED.

INSULATED GROUNDING BUSHINGS SHALL BE REQUIRED FOR ALL RACEWAYS ENTERING SERVICE ENTRANCE PANELS, DISTRIBUTION PANELS, ALL RACEWAYS WITH #4 OR LARGER CONDUCTORS AND ANY RACEWAY ENTERING A CONCENTRIC KNOCK-OUT.

EQUIPMENT GROUNDING:

GENERA

IN GENERAL A GROUND WIRE SHALL BE INSTALLED IN EVERY CONDUIT. THE CONDUIT INSTALLATION ITSELF SHALL SERVE AS AN ADDITIONAL GROUNDING MEANS.

WHERE CONDUITS TERMINATE WITHOUT MECHANICAL CONNECTION (I.E. LOCKNUTS AND BUSHINGS) TO PANELBOARDS, AND FOR ALL TERMINATIONS OF CONDUIT WITH #4 OR LARGER; AND FOR ALL SIZES OF METALLIC CONDUIT (RIGID OR FLEXIBLE) TERMINATING IN CONCENTRIC KNOCKOUTS, THE FOLLOWING PROCEDURE SHALL BE FOLLOWED: EACH CONDUIT SHALL BE PROVIDED WITH AN INSULATING GROUND BUSHING AND EACH BUSHING CONNECTED WITH A BARE COPPER CONDUCTOR TO THE GROUND BUS IN THE ELECTRICAL EQUIPMENT. THE GROUND CONDUCTOR SHALL BE IN ACCORDANCE WITH THE ARTICLE OF GROUNDING OF NEC.

LIGHTING FIXTURES:

IT IS THE CONTRACTOR'S RESPONSIBILITY TO VERIFY CATALOG NUMBERS IN THE FIXTURE SCHEDULE TO ENSURE THAT MATCHES THE DESCRIPTION GIVEN AND FOR PROPER CEILING MOUNTING, REQUIRED ACCESSORIES,

ALL OUTSIDE FIXTURES SHALL BE SEALED TO PREVENT THE ENTRY OF INSECTS INTO THE LIGHT FIXTURES OR CONDUIT SYSTEM.

TRANSFORMERS

GENERAL: DRY TYPE TRANSFORMERS SHALL BE FACTORY ASSEMBLED, METAL ENCLOSE, PROVIDED COMPLETE WITH MOUNTING BRACKETS AS REQUIRED.

INSULATION: CLASS H INSULATION SHALL BE EMPLOYED FOR TRANSFORMERS ABOVE 30 KVA WITH MAXIMUM TEMPERATURE RISE OF 150 DEGREES C. OVER 40 DEGREES CLASS F INSULATION SHALL BE EMPLOYED FOR TRANSFORMERS UP TO AND INCLUDING 30 KVA WITH A MAXIMUM TEMPERATURE RISE OF 115 DEGREES C. OVER 40 DEGREES C. DEGREES C.

WINDINGS: THREE PHASE UNITS SHALL BE WOUND DELTA-WYE. EACH THREE PHASE TRANSFORMER SHALL HAVE THREE SEPARATE SETS OF COILS. NO SCOTT T CONNECTIONS, OPEN DELTA, OR TWO COIL ARRANGEMENTS SHALL BE PERMITTED.

MOTORS AND MOTOR CONTROLS:

MOTOR STARTERS SHALL BE ACROSS—THE—LINE MAGNETIC TYPE SIZED FOR MOTOR HORSEPOWER. OVERLOADS SHALL BE PROVIDED IN EACH PHASE. HAND—OFF—AUTO SELECTOR SWITCHES, RUN PILOT LIGHTS AND AUXILIARY CONTACTS SHALL BE INCLUDED. CONTROL SHALL BE 120V. ALL CONTROL, ALARM AND INTERLOCK WRING SHALL BE IN CONDUIT AND SHALL BE COLOR CODED.

FIRE ALARM SYSTEM:

DESCRIPTION:

FURNISH, INSTALL, AND PLACE INTO OPERATING CONDITION AN EXTENSION TO THE EXISTING BUILDING FIRE ALARM SYSTEM AS SHOWN ON THE PLANS. THE FIRE ALARM SYSTEM SHALL BE LISTED BY UNDERWRITERS' LABORATORIES INC., BE ADA COMPLIANT, BE CONSTRUCTED AND INSTALLED IN STRICT ACCORDANCE WITH THE NATIONAL FIRE PROTECTION ASSOCIATION 70 AND 72 AND COMPLY WITH THE APPLICABLE REQUIREMENTS OF STATE AND LOCAL CODES AND THE NATIONAL ELECTRICAL CODE. THE SYSTEM SHALL USE CLOSED LOOP INITIATING DEVICE CIRCUITS WITH INDIVIDUAL ZONE SUPERVISION.

IT SHALL BE THE RESPONSIBILITY OF THE CONTRACTOR TO COORDINATE RELATED WORK WITH ALL TRADES INVOLVED. THE EQUIPMENT SHALL BE OF THE SAME MANUFACTURER AS THE EXISTING SYSTEM.

SHOP DRAWINGS:

SHOP DRAWINGS SHALL BE COMPLETE WITH DETAIL INFORMATION ON ALL SYSTEM COMPONENTS AS WELL AS SYSTEM WIRING DIAGRAMS.

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PRODUCTS:

MANUFACTURERS:

THE EQUIPMENT SHALL BE OF THE SAME MANUFACTURER AS THE EXISTING SYSTEM.

MANUAL PULL STATIONS:

SINGLE ACTION NON-CODED.

DUCT SMOKE DETECTORS:

PHOTOELECTRIC TYPE, UL LISTED. PROVIDE WITH REMOTE STATUS INDICATORS.

ALARM SIGNALS:

ALARM SIGNALS SHALL BE CHIMES AND STROBES AS SHOWN ON THE PLAN. STROBES SHALL MEET THE MINIMUM CANDELA RATING REQUIRED BY ADA. CHIMES SHALL BE ELECTRONIC TYPE, RECESSED AND HAVE A MINIMUM OUTPUT OF 83 Db AT 10 FEET.

WIRIN

WIRING SHALL BE STRANDED #14 AWG, COLOR CODED, AND NUMBERED. INSULATION SHALL BE TYPE THHN OR XHHW.

INSTALLATION:

ALL FIRE ALARM WIRING SHALL BE INSTALLED IN METAL RACEWAYS.
JUNCTION BOXES SHALL BE SIZED IN ACCORDANCE WITH THE NUMBER OF
WIRES AND TERMINATIONS TO BE INSTALLED. JUNCTION BOXES HAVING
MORE THAN TWELVE TERMINATIONS SHALL HAVE TERMINAL STRIPS.
ALL CONNECTIONS SHALL BE MADE BY OR UNDER THE DIRECT
SUPERVISION OF A QUALIFIED SYSTEM TRAINED TECHNICIAN.

CERTIFICATION:

UPON COMPLETION OF INSTALLATION, THE ENTIRE SYSTEM SHALL BE TESTED BY THE MANUFACTURER'S TECHNICIAN IN THE PRESENCE OF REPRESENTATIVES OF THE OWNER, THE ARCHITECT, AND THE LOCAL AUTHORITY HAVING JURISDICTION. A CERTIFICATION SHALL BE FORWARDED TO THE ARCHITECT AND ENGINEER BY THE TECHNICIAN STATING THAT HE HAS PERSONALLY VERIFIED THE FOLLOWING:

THE SYSTEM BEING IN ACCORDANCE WITH THE SPECIFICATIONS; THE SYSTEM BEING IN CORRECT OPERATING CONDITION.

THE ARCHITECT SHALL BE NOTIFIED OF THE DATES AND TIMES PROPOSED FOR THE SYSTEM TESTING. TESTS SHALL NOT BE PERFORMED WITHOUT THE ARCHITECT'S APPROVAL.
ALL EQUIPMENT AND LABOR SHALL BE GUARANTEED FOR A PERIOD OF ONE YEAR FROM ACCEPTANCE.

SURGE SUPPRESSION, BONDING AND GROUNDING:

SURGE SUPPRESSION EQUIPMENT SHALL BE PROVIDED FOR ALL NEW DISTRIBUTION EQUIPMENT. IT SHALL BE INSTALLED ON THE MAIN ELECTRICAL SERVICE, ALL DISTRIBUTION PANELS AND SELECTED SUB-PANELS, POWER SUPPLIES OF SPECIAL SYSTEMS, AND ON CIRCUITS FEEDING SELECTED MAJOR ITEMS THAT HAVE A SENSITIVE ELECTRICAL NATURE. A BONDING AND SINGLE POINT GROUNDING SYSTEM SHALL BE PROVIDED TO INTERCONNECT THE MAIN ELECTRIC SERVICE GROUND, LIGHTNING PROTECTION SYSTEM GROUNDS AND ALL SPECIAL ELECTRONIC SYSTEM ISOLATED GROUNDS.

LIGHTING AND APPLIANCE PANELS:

INTERRUPTING RATINGS SHALL BE COORDINATED WITH THE AVAILABLE SHORT CIRCUIT CURRENT. BRANCH CIRCUIT PROTECTION DEVICES SHALL BE MOLDED CASE CIRCUIT BREAKERS BOLT—ON TYPE.

HARDWARE SHALL CONSIST OF COMBINATION LATCH AND LOCK, ALL KEYED THE SAME.

PANEL ENCLOSURES SHALL BE FURNISHED WITHOUT KNOCKOUTS. ALL KNOCKOUTS TO BE FIELD CUT.

TYPED DIRECTORY CARDS SHALL BE FURNISHED IN EACH PANEL.

ALL PANELS SHALL BE PROVIDED WITH AN EQUIPMENT GROUNDING BUS SIMILAR TO, BUT ISOLATED FROM THE SOLID-NEUTRAL BUS.

PANELS SHALL BE CAREFULLY ALIGNED AND RIGIDLY SECURED IN PLACE WITH THE TOP OF THE CABINETS LOCATED 78 INCHES ABOVE THE FINISHED FLOOR. FLUSH MOUNTED PANEL SHALL HAVE EIGHT (8) 1" EMPTY CONDUITS RUN FROM THE PANEL TO AN ACCESSIBLE LOCATION ABOVE THE CEILING. THE EMPTY CONDUITS SHALL BE CAPPED AND MARKED TO INDICATE THEIR ORIGIN.

EACH PANEL SHALL BE FURNISHED WITH AN IDENTIFICATION PLATE AS SPECIFIED IN THE "EQUIPMENT IDENTIFICATION" SECTION OF THIS SPECIFICATION.

ALL PANELBOARDS SHALL BE MANUFACTURED BY GE.

SEAL SEAL ., Inc.

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TIMESHARE MOB2 SUITE #2371

SHEET NAME:
ELECTRICAL
SPECIFICATIONS

SCALE: AS NOTED

LOG NO. T:\Baptist Health...\Drawings\

C & A FN: 3943

Est. Project GSF:

BOMA SF:

SHEET NUMBER:

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					.3T2	1HF)						
MAIN SIZE (AMPS) & TYPE: PANEL RATING (AMPS): NEUTRAL:			<u> </u>						TAGE/PHASE/WIRES: 480/277/3/4 LT CURRENT RATING: 10000 LOCATION:				
MOUNTING:											FED FROM		
NOTES												1.6	
C K DESCRIPTION		NOTE TRI	. L			kVA				I Note	DESCRIPTION	K	
				Α		В	(С	TRIP	INOIL	DESCRIPTION	Ϊ́T	
1 LTG HALL WAITING		20/	1 0.6	0.7								7 2 4	
3 LTG BREAK CK IN/OUT DR OFFICE EXAM-1 EXALEXAM-4 HC TIT JAN, LAB MGR OFFICE	M-2 EXAM-3	20/	1		0.9	0.7			15/3		HT VTU 3-21 HALL	4	
5 SPARE		20/		_				0.7	'				
7 SPARE		20/	i					J.,	20/1		SPARE	6 8	
9 SPARE		20/							20/1		SPARE	10	
11 SPARE		20/							20/1		SPARE	10 12 14 16 18 20 22 24 26 28 30 32 34 36	
13 SPARE		20/	1	1.0								14	
15 SPARE		20/				1.0			20/3	3 HT	HT VTU 3–23 HALL		
17 SPARE		20/						1.0				18	
19 SPARE		20/							20/1		SPARE	20	
21 SPARE		20/							20/1		SPARE	22	
23 SPARE		20/							20/1		SPARE	24	
25 SPARE		20/							20/1		SPARE	26	
27 SPARE		20/				<u> </u>			20/1		SPARE	28	
29 SPARE		20/							20/1		SPARE	30	
31 SPARE		20/		<u> </u>					20/1		SPARE	32	
33 SPARE		20/		+					20/1		SPARE	34	
35 SPARE		20/							20/1		SPARE	36	
37		50/	4.4		4.1				20/1		SPARE SPARE	38	
39 41 T-3T5		30/	³ 📙	+	4.1		1.4		20/1		SPARE	42	
NO SUBFEED LUGS						_	1.4		20/1		SPARE	42	
EXISTING LOAD			+			<u> </u>	 						
TOTAL				 6.7		5.7		5.1					
BALANCE RATIO				0.7	\vdash	.,	۱۳	/• I					
LOAD TYPE	CON	NECTED kVA		QUANTI	Ϋ́	1	FACTOR	₹	CODF	SIZIN	IG KVA COMMENTS		
Heating		8.0		3			1.00	•	1000	8.0			
Interior Lighting		1.5		26			1.25			1.9			
Other		0.5		1			1.00			0.5			
Receptacle		<6.4>											
OkVA TO 10kVA		6.4					1.00			6.4			
TOTALS		16.4					1.02			16.8			
									20	.2 AV	IPS		

						<u>3</u> T2	11 F)					
	MAIN SIZE (AMPS) & TYPE: MLO PANEL RATING (AMPS): 100 NEUTRAL:					<u> </u>						TAGE/PHASE/WIRES: 208/120/3/4 T CURRENT RATING: 10000 LOCATION:	
	MOUNTING											FED FROM T-3T5	
	NOTES:												
K	DESCRIPTION	NOTE	TRIP		Α	k\ E			<u> </u>	TRIP	NOTE	DESCRIPTION	C K T
	REC DR OFFICE MGR OFFICE		20/1	0.8	1.5					70 /0			2
	REC EXAM-3 EXAM-4		20/1			0.8	1.5			30/2		HT EWH-1 JAN.	4
5	REC EXAM-1 EXAM-2		20/1					0.8		20/1		SPARE	6
7	REC WAITING		20/1	0.6						20/1		SPARE	8
9	REC CK IN/OUT		20/1			0.6				20/1		SPARE	10
11	REC COPIER CK IN/OUT		20/1					0.2		20/1		SPARE	12
13	O IS CL. REC WIRELESS NETWORK HALL IS CL. LAB		20/1	1.3						20/1		SPARE	14
15	REC LAB		20/1			0.6				20/1		SPARE	16
17	REC COFFEE MAKER BREAK		20/1					0.2		20/1		SPARE	18
	REC REFRIGERATOR BREAK		20/1	0.2						20/1		SPARE	20
21	REC BREAK HALL		20/1			0.6				20/1		SPARE	22
23	REC TIME CLOCK, RECIRC PUMP JAN.		20/1					0.2		20/1		SPARE	24
25	SPARE		20/1							20/1		SPARE	26
27	SPARE		20/1							20/1		SPARE	28
29	SPARE		20/1							20/1		SPARE	30
31	SPARE		20/1	-						20/1		SPARE	32
33	SPARE		20/1							20/1		SPARE	34
35	SPARE		20/1							20/1		SPARE	36
37	SPARE		20/1							20/1		SPARE	38
39	SPARE		20/1							20/1		SPARE	40
41	SPARE		20/1							20/1		SPARE	42
NO	SUBFEED LUGS			_	_	_	_	_	_				
	TING LOAD			<u> </u>	_	_	_	 	_				
TOT				4	.4	4	.1	1.	4				
	ANCE RATIO												
LOA		CONNECTED	kVA		ZUANTIT	Ϋ́		FACTOR		CODE	SIZIN	G KVA COMMENTS	
Hea		3.0			1			1.00		<u>-</u>	3.0		
Oth		0.5			1			1.00			0.5		
	eptacle	<6.4>											
	kVA TO 10kVA	6.4						1.00			6.4		
TOT		9.9						1.00			9.9		
T		- 7.0								27	7.5 AM	PS	
				-									

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TIMESHARE MOB2 SUITE #2371

SHEET NAME: ELECTRICAL PANEL SCHEDULES

SCALE: AS NOTED

LOG NO. T:\Baptist Health...\Drawings\

C & A FN: 3943

Est. Project GSF:

BOMA SF:


SHEET NUMBER:

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- REFER TO ARCHITECTURAL ELEVATIONS FOR FINAL MOUNTING HEIGHTS OF ALL DEVICES. UNLESS NOTED OTHERWISE, ARCHITECTURAL ELEVATIONS SHALL DICTATE MOUNTING HEIGHTS OF ALL FIXTURES.
- 2. VERIFY AND COORDINATE EXACT ELECTRICAL REQUIREMENTS OF ALL EQUIPMENT WITH MANUFACTURER'S RECOMMENDATIONS PRIOR TO INSTALLATION OF EQUIPMENT.
- FIRE ALARM CONTRACTOR SHALL FULLY TEST ALL INITIATING DEVICES WITHIN THE SMOKE COMPARTMENT TO ENSURE THAT ALL DEVICES ARE CORRECTLY ANNUNCIATING THE CORRECT SMOKE COMPARTMENT IDENTIFICATION, AS SHOWN ON THE LIFE SAFETY PLAN. CONTRACTOR SHALL CORRECT ANY AND ALL DISCREPANCIES FOUND DURING SAID TESTING PROCEDURE.
- COORDINATE ALL T.V. OUTLET LOCATIONS AND MOUNTING HEIGHTS WITH ARCHITECTURAL DRAWINGS/ELEVATIONS. T.V. OUTLETS SHALL BE INSTALLED AS SHOWN ON DETAIL SHEET AND COORDINATED WITH T.V. BRACKET LOCATION.
- COORDINATE ALL VOICE/DATA OUTLET LOCATIONS AND MOUNTING HEIGHTS WITH ARCHITECTURAL DRAWINGS/ELEVATIONS. PROVIDE BACKBOX AND PULL STRING TO ACCESSIBLE CEILING FOR ALL VOICE/DATA OUTLETS SHOWN ON THIS PLAN.
- 6. RECEPTACLES REPRESENTED BY A 'H' INDICATES HOSPITAL GRADE RECEPTACLES.

POWER PLAN KEY NOTES:

- 1 RECEPTACLE FOR WIRELESS NETWORK EQUIPMENT. COORDINATE LOCATION OF DEVICE WITH OWNER PRIOR TO ROUGH-IN.
- (2) CONNECT CIRCUIT FOR ELECTRIC WATER HEATER AND RECIRCULATION PUMP (RP-1) THROUGH TIME CLOCK. REFER TO DETAIL 4 ON SHEET E3.1.
- $\overline{3}$ PROVIDE ROUGH-IN FOR OWNER PROVIDED DOOR RELEASE PUSH BUTTON.
- \langle 4 \rangle PROVIDE ROUGH-IN FOR OWNER PROVIDED DOOR RELEASE MECHANISM.
- $\langle 5 \rangle$ PROVIDE 1" CONDUIT BETWEEN DOOR RELEASE MECHANISM AND PUSH BUTTON.
- $\langle 6 \rangle$ TRANSFORMER T-3T4LP. REFER TO DETAIL 1, SHEET E3.1 FOR MOUNTING DETAILS.
- (7) LOW VOLTAGE POWER FOR VTU CONTROLS.

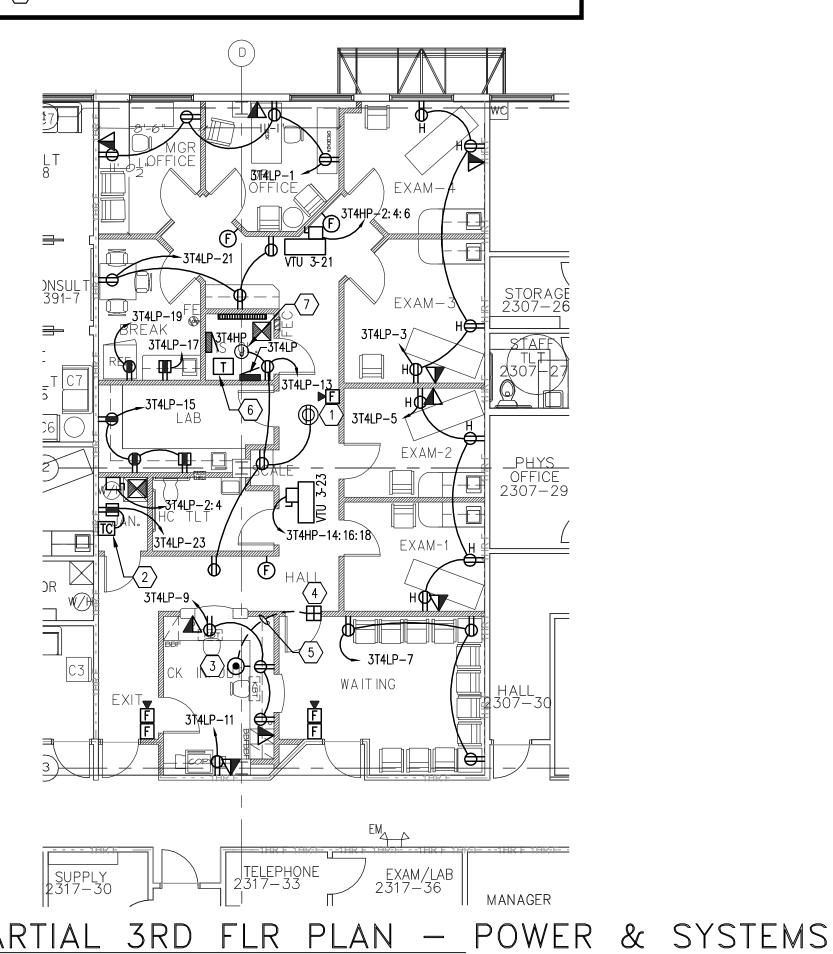


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DEMOLITION PLAN GENERAL NOTES:

- 1. DEMOLITION PLAN IS NOT INCLUDED FOR THE PROJECT AREA. THE CONTRACTOR SHALL VISIT THE SITE AND DEVELOP A GENERAL KNOWLEDGE OF THE EXISTING CONDITIONS WITHIN THE PROJECT AREA. THE CONTRACTOR IS RESPONSIBLE FOR ALL REQUIRED DEMOLITION.
- 2. ALL CONDUITS SERVING OTHER SPACES OR FLOORS, THAT RUN THROUGH THE PROJECT AREA SHALL REMAIN ACTIVE DURING CONSTRUCTION, SO AS NOT TO CAUSE ANY DISRUPTION TO THESE OTHER SPACES. IT IS THE CONTRACTOR'S RESPONSIBILITY TO INSURE THAT ALL CONDUITS, NEW OR EXISTING, WITHIN THE PROJECT AREA ARE PROPERLY SUPPORTED AND PROVIDED WITH BONDING BUSHINGS IN ACCORDANCE WITH THE NATIONAL ELECTRIC CODE.
- 3. ALL ITEMS REMOVED UNDER THIS PROJECT SHALL BE DISPOSED OF OR TURNED OVER TO THE OWNER AT THE OWNER'S DISCRETION.
- THIS CONTRACTOR SHALL PROVIDE ELECTRICAL FOR PHASING WORK AS REQUIRED OR DIRECTED BY THE ARCHITECT, REFER TO ARCHITECTURAL PHASING PLAN. TEMPORARY ELECTRICAL SERVICES (POWER, LIGHTING, NURSE CALL, FIRE ALARM, ETC) SHALL BE PROVIDED WHEN NEW WORK AFFECTS SERVICES NEEDING TO REMAIN ACTIVE. IF FIRE ALARM SYSTEM CANNOT BE MAINTAINED IN THE CONSTRUCTION AREA, A FIRE WATCH SHALL BE PROVIDED.
- 5. UNLESS OTHERWISE NOTED, ALL EQUIPMENT, WIRING DEVICES, LIGHT FIXTURES, CONDUIT AND WIRE IN THE PROJECT AREA SHALL BE REMOVED. THE CONTRACTOR SHALL INVESTIGATE THE PROJECT AREA PRIOR TO BID TO DETERMINE ALL REQUIRED DEMOLITION.
- 6. CONTRACTOR SHALL PROVIDE MEANS OF AUTOMATIC SMOKE DETECTION VIA INSTALLED SMOKE DETECTORS CONNECTED TO THE FACILITY FIRE ALARM SYSTEM FOR COVERAGE DURING NON- OCCUPIED PERIODS WITHIN THE CONSTRUCTION AREA. IF DESIRED, A DOCUMENTED FIRE WATCH OF THE ENTIRE AREA PERFORMED IN INCREMENTS NO GREATER THAN ONE HOUR MAY BE PERFORMED PROVIDED THAT IT IS DOCUMENTED IN FULL ACCORDANCE WITH NFPA 72. COORDINATE ACTIVITY IN FIELD WITH GENERAL CONTRACTOR.



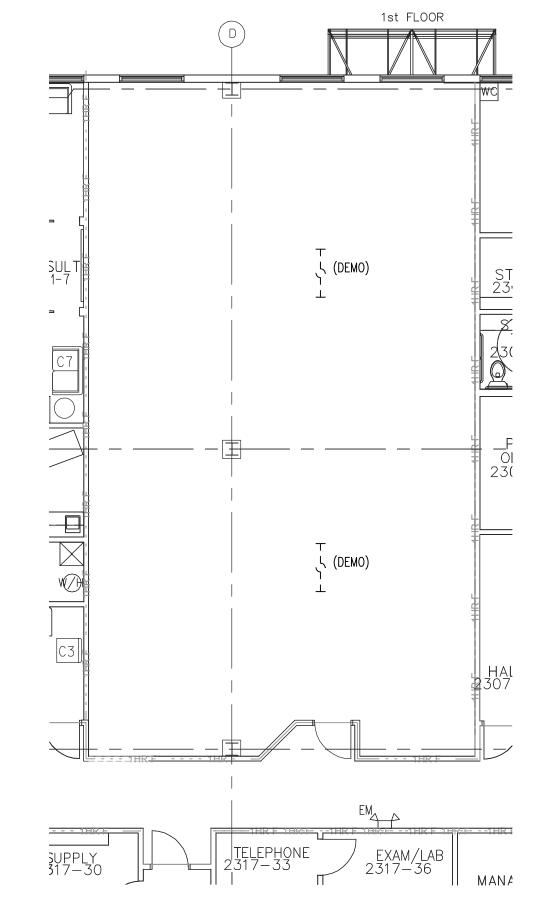

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TIMESHARE MOB2 SUITE #2371

SHEET NAME:

PARTIAL 3RD FLR PLA POWER & DEMOLITION

SCALE: AS NOTED

LOG NO. T:\Baptist Health...\Drawings

C & A FN: 3943

Est. Project GSF:

BOMA SF:

SHEET NUMBER:

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TIMESHARE MOB2 SUITE #2371

SHEET NAME:			
PARTIAL	3RD	FLR	PLAN
LIGHTING	j		

SCALE: AS NOTED

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	LIGHTING FIXTURE SCHEDULE											
TYPE	DESCRIPTION	MANUFACTURER	MODEL NUMBER	VOLTAGE		REQUIRED LAMPS		REMARKS				
A2	2X4, 2 LAMP, RECESSED, LENSED STATIC TROFFER, FLUSH ALUMINUM DOOR WITH MITERED CORNERS125" LENS	LIGHTOLIER	SPS2GFSVA232-277S0	277	NUM. 2	TYPE F32T8	64					
A2E	2X4, 2 LAMP, RECESSED, LENSED STATIC TROFFER, FLUSH ALUMINUM DOOR WITH MITERED CORNERS125" LENS	LIGHTOLIER	SPS2GFSVA232-277SO-EM	277	2	F32T8	64	PROVIDE BATTERY BACKUP FOR 1100 LUMINS				
A3E	2X4, 3 LAMP, RECESSED, LENSED STATIC TROFFER, FLUSH ALUMINUM DOOR WITH MITERED CORNERS125" LENS	LIGHTOLIER	SPS2GFSVA332-277SO-EM	277	3	F32T8	96	PROVIDE BATTERY BACKUP FOR 1100 LUMINS				
B2	2X4, 2 LAMP, RECESSED, 12 CELL PARABOLIC FIXTURE WITH 3" DEEP LOW IRIDESCENT LOUVER	LIGHTOLIER	DPS2G18LP232-277S0	277	2	F32T8	64					
B2E	2X4, 2 LAMP, RECESSED, 12 CELL PARABOLIC FIXTURE WITH 3" DEEP LOW IRIDESCENT LOUVER	LIGHTOLIER	DPS2G18LP232-277SO-EM	277	2	F32T8	64	PROVIDE BATTERY BACKUP FOR 1100 LUMINS				
J1	4', 1 LAMP FLUORESCENT STRIP, PENDANT MOUNTED, WITH CLEAR LAMP SLEEVE AND WIRE GUARD	LIGHTOLIER	SW140RSHPF277S0-AWG3W-AH5CSP	277	1	F32T8	32					
X	LED EXIT SIGN FIXTURE, UNIVERSAL MOUNT, RED LETTERS WITH BLACK HOUSING AND BRUSHED ALUMINUM FACE - SINGLE OR DOUBLE FACE	LIGHTOIER	LDSNURA	277	NA	LED	10	COORDINATE MOUNTING HEIGHT WITH ARCHITECT. FINISH TO BE SELECTED BY ARCHITECT.				


GENERAL LIGHTING PLAN NOTES:

- 1. REFER TO ARCHITECTURAL CEILING PLAN FOR EXACT LOCATION OF ALL LIGHT FIXTURES.
- 2. REFER TO ARCHITECTURAL ELEVATIONS FOR FINAL MOUNTING HEIGHTS OF ALL WALL MOUNTED LIGHT FIXTURES. UNLESS NOTED OTHERWISE, ARCHITECTURAL ELEVATIONS SHALL DICTATE MOUNTING HEIGHTS OF ALL FIXTURES.
- 3. SURFACE MOUNTED RACEWAY IS NOT PERMITTED FOR INTERCONNECTION BETWEEN MULTIPLE UNDERCABINET LIGHT FIXTURES. BACKFEED ALL FIXTURES. TYPICAL FOR ALL LOCATIONS.

LIGHTING PLAN KEY NOTES:

- PROVIDE WALL MOUNTED, LOW VOLTAGE SWITCH FOR OCCUPANCY SENSOR OVERRIDE. REFER TO DETAIL 5 ON SHEET E3.1.

PARTIAL	3RD	FLR	PLAN	_	LIGHTING
PARTIAL SCALE: 1/8" = 1'-	O"				

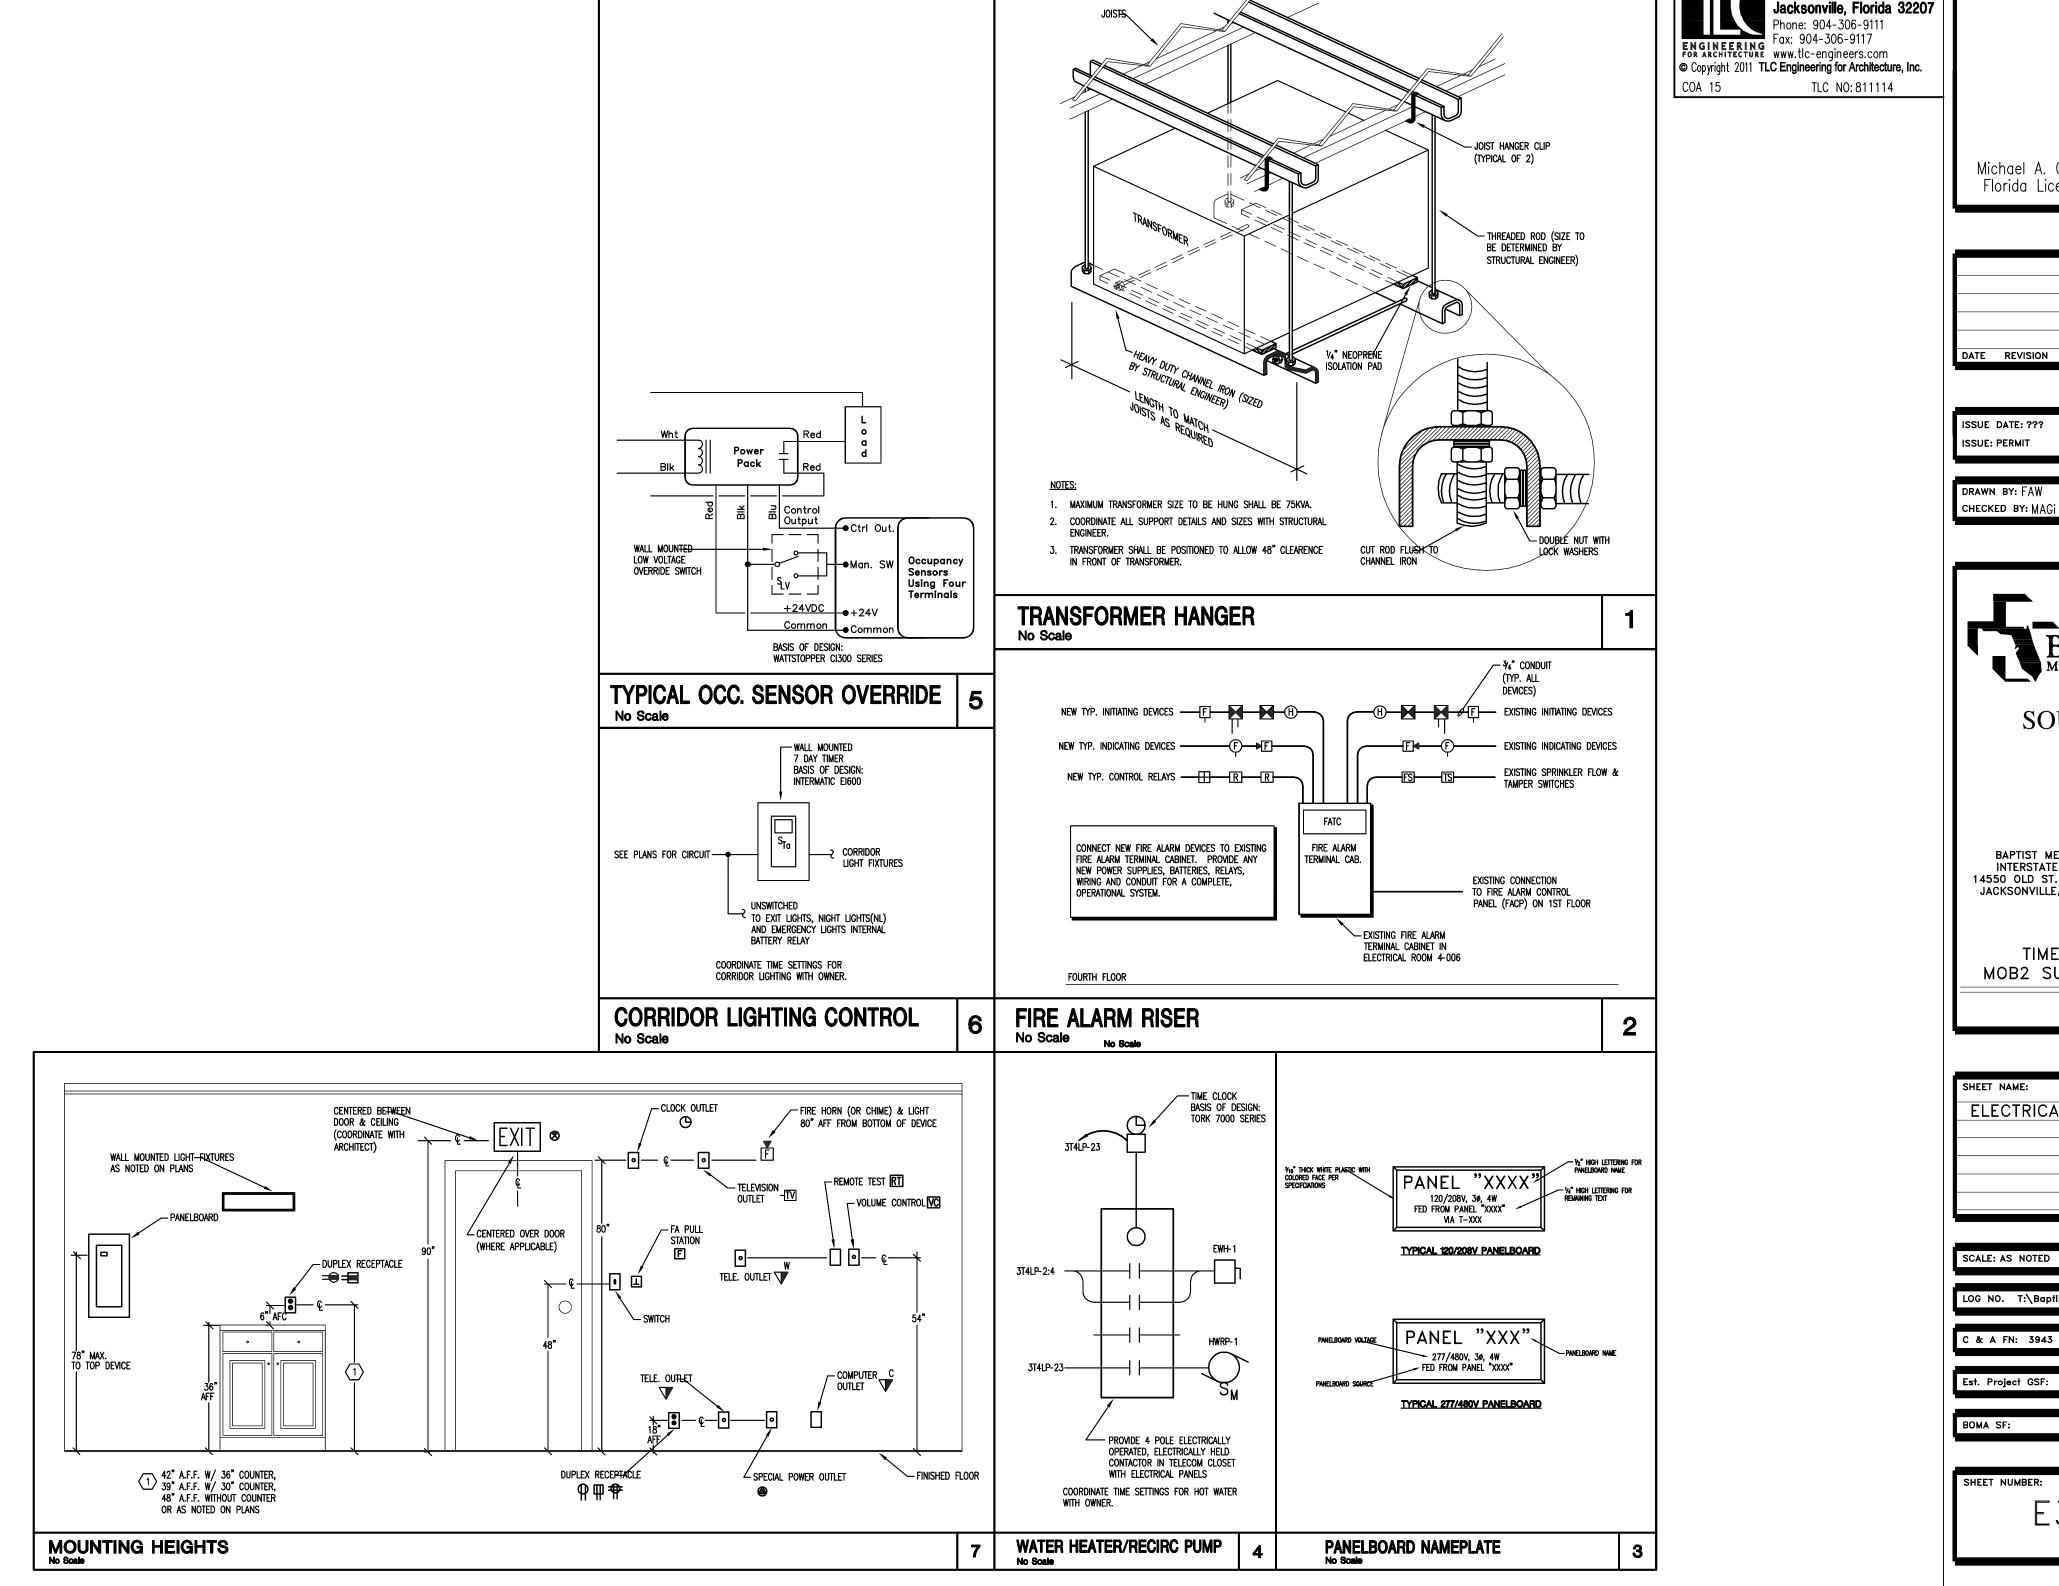

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ELECTRICAL DETAILS

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